

NOTE: REVISION 4 INCLUDES A PROPERTY LINE ADJUSTMENT BASED ON THE 11/28/16 SURVEY BY GODFREY-HOFFMAN & ASSOC.

UNITED ILLUMINATING
ENGLISH STATION POWER PLANT
510 Grand Avenue New Haven, Connecticut

200'

SITE PLAN AND APPROXIMATE **PARCEL BOUNDARIES**

DRAWN BY:	KDH	PROJ NO.:	263951-000001-000000
CHECKED BY:	RG		
APPROVED BY:	MM		FIGURE 2-1
DATE:	10/07/2016		





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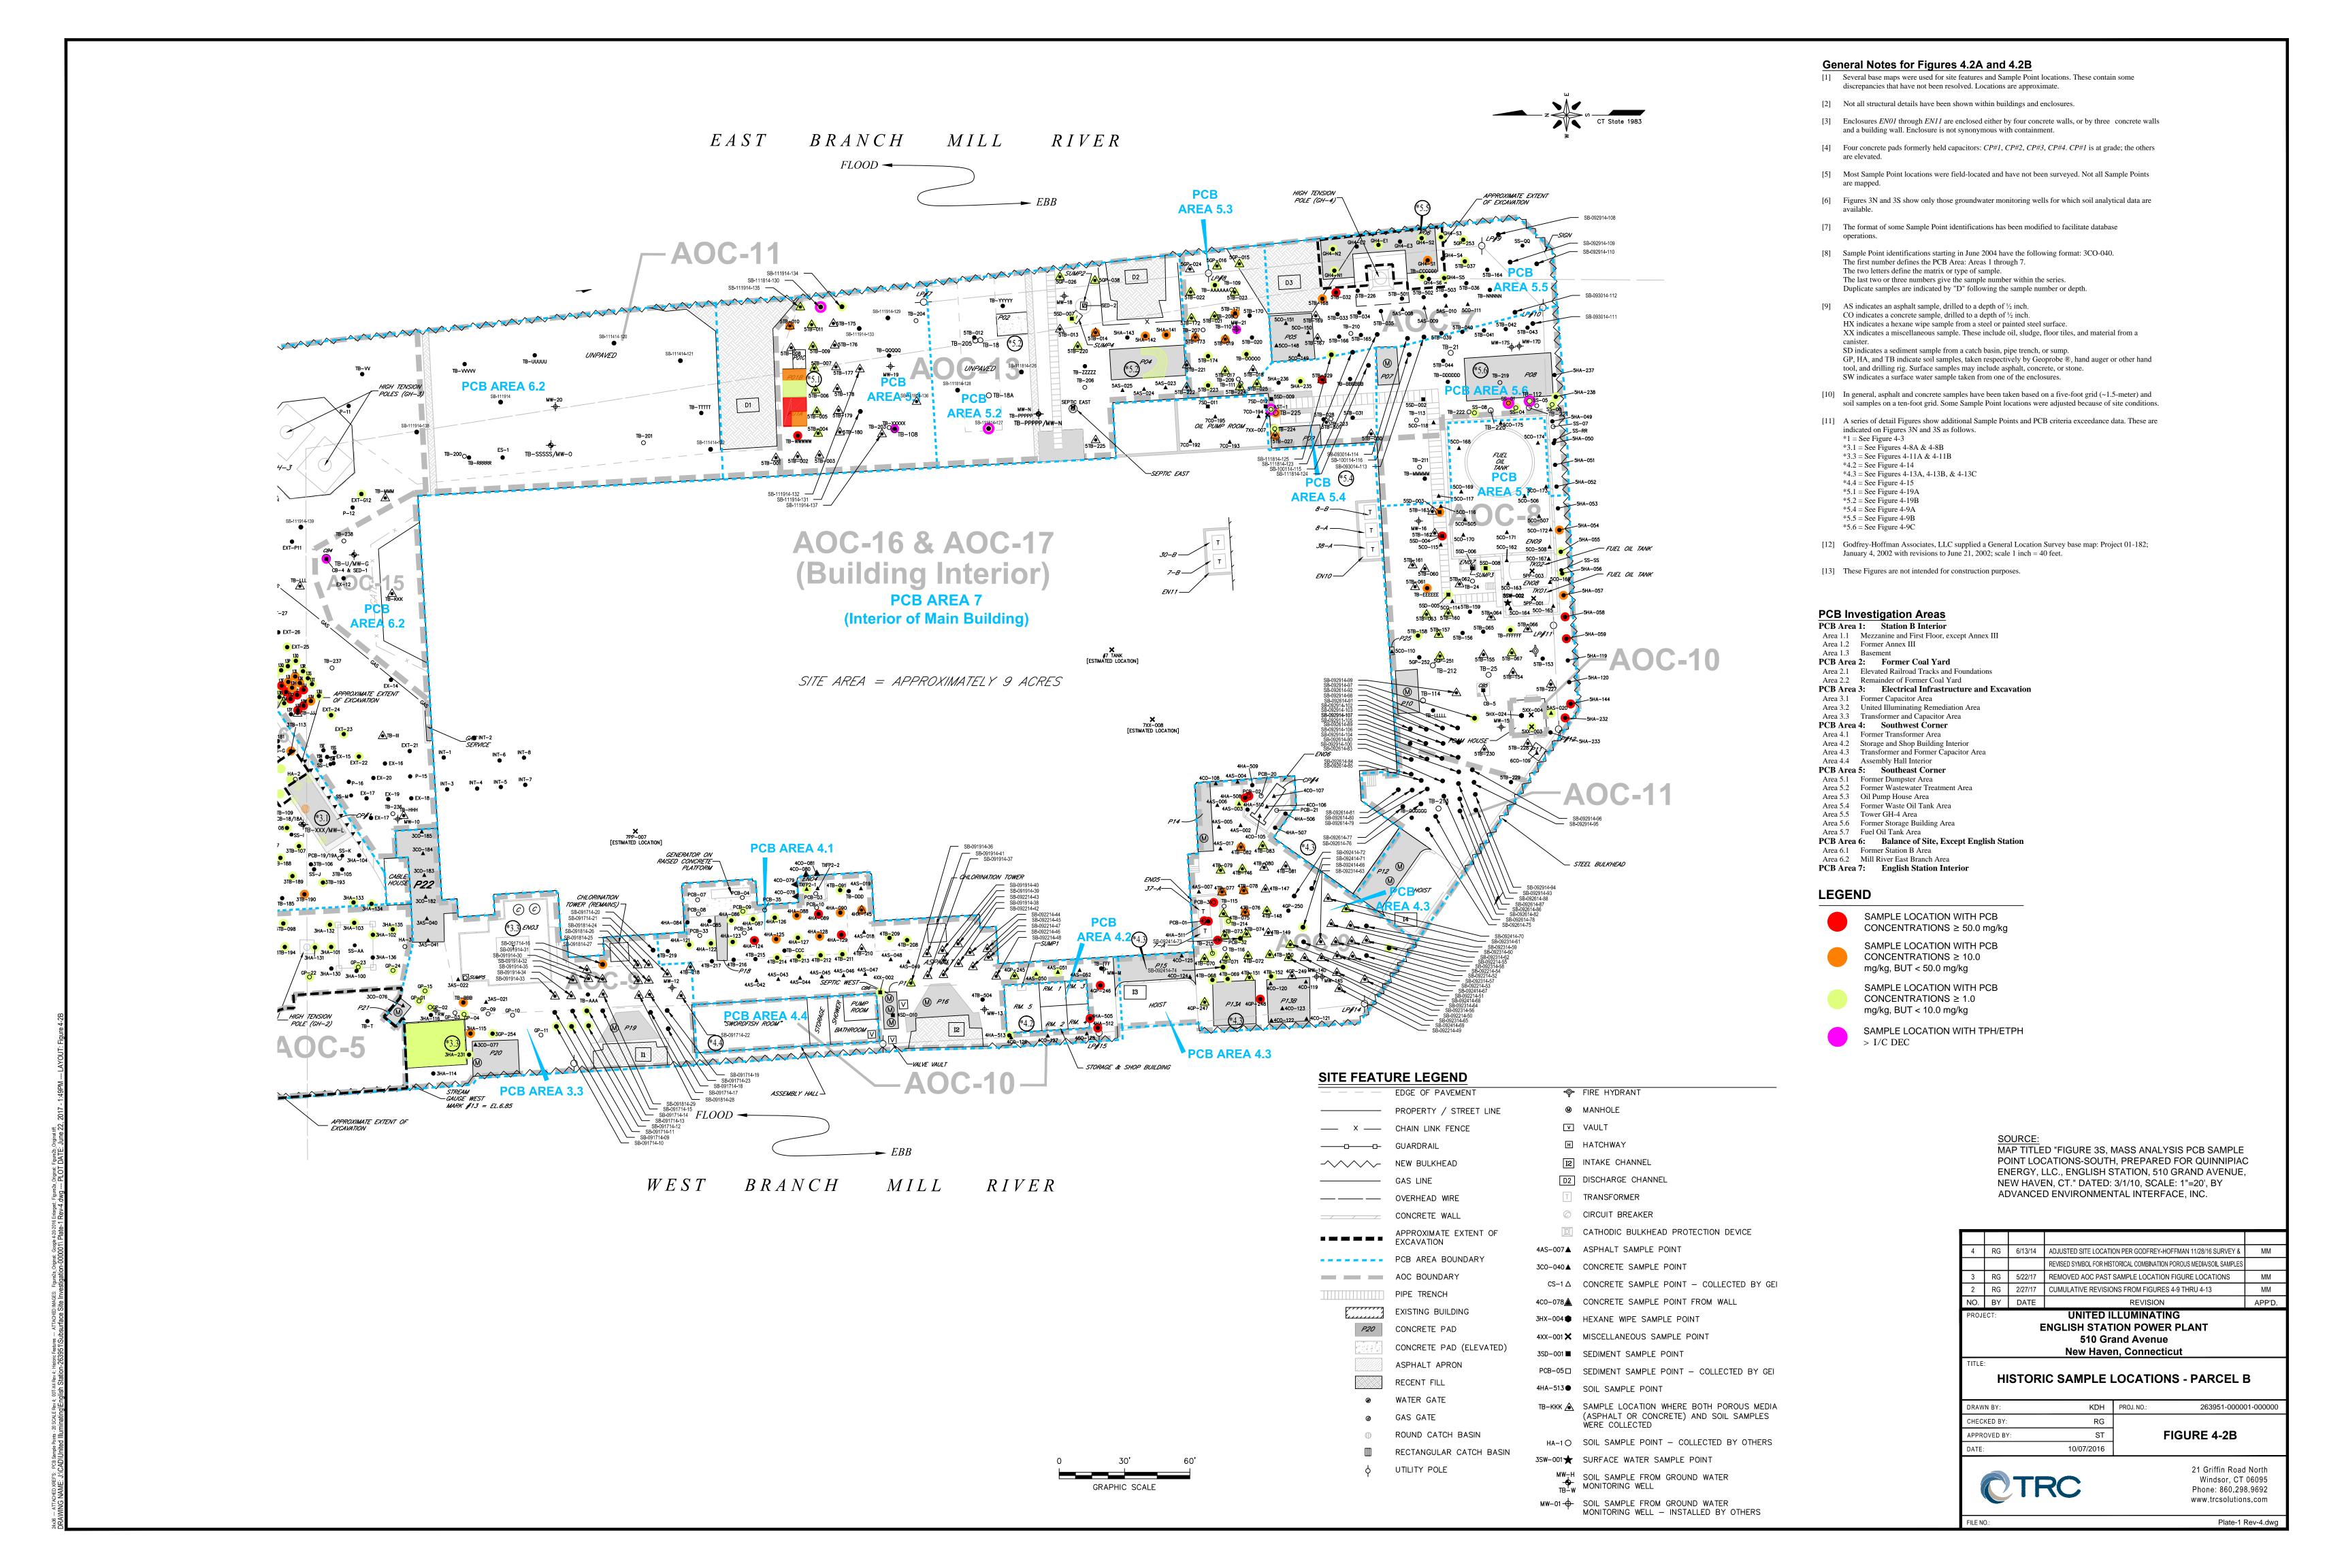
GRAPHIC SCALE


SOURCE:


- MAP TITLED "FIGURE 3N, MASS ANALYSIS PCB SAMPLE POINT LOCATIONS-NORTH, PREPARED FOR QUINNIPIAC ENERGY, LLC., ENGLISH STATION, 510 GRAND AVENUE, NEW HAVEN, CT." DATED: 3/1/10, SCALE: 1"=20', BY ADVANCED ENVIRONMENTAL INTERFACE, INC.
- AERIAL IMAGE FROM GOOGLE EARTH PRO, DATE OF IMAGE: 04/20/2016




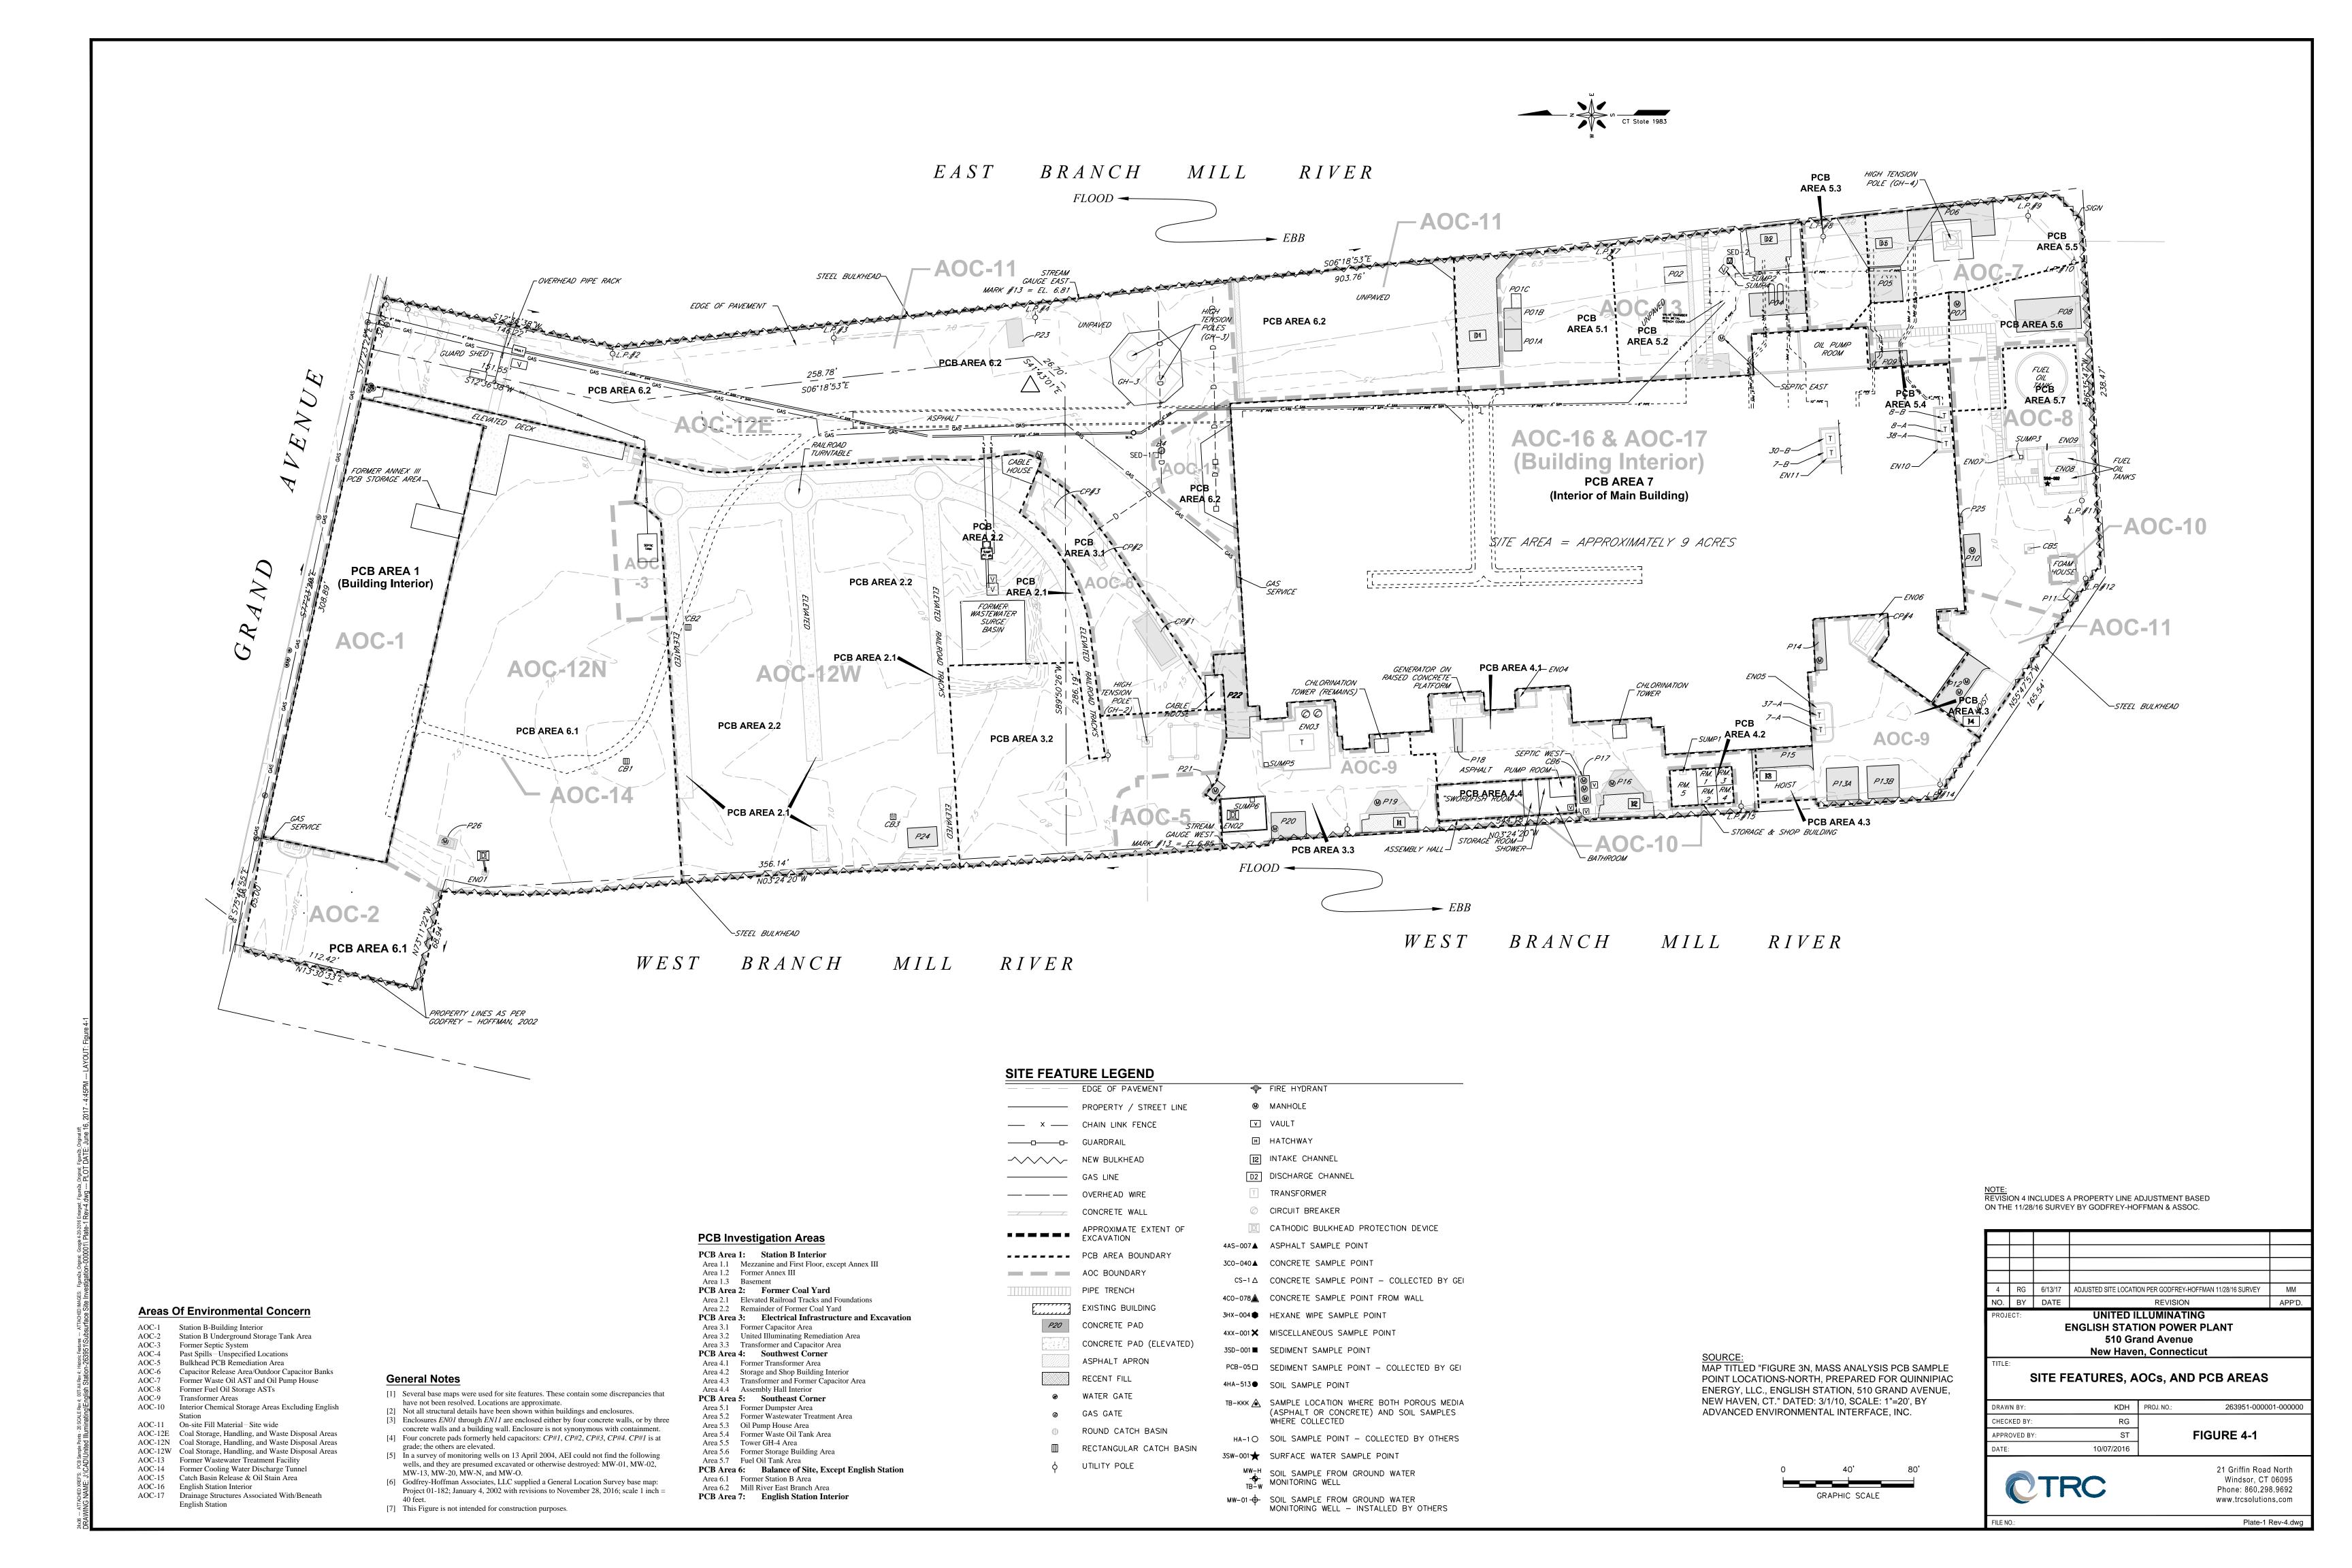

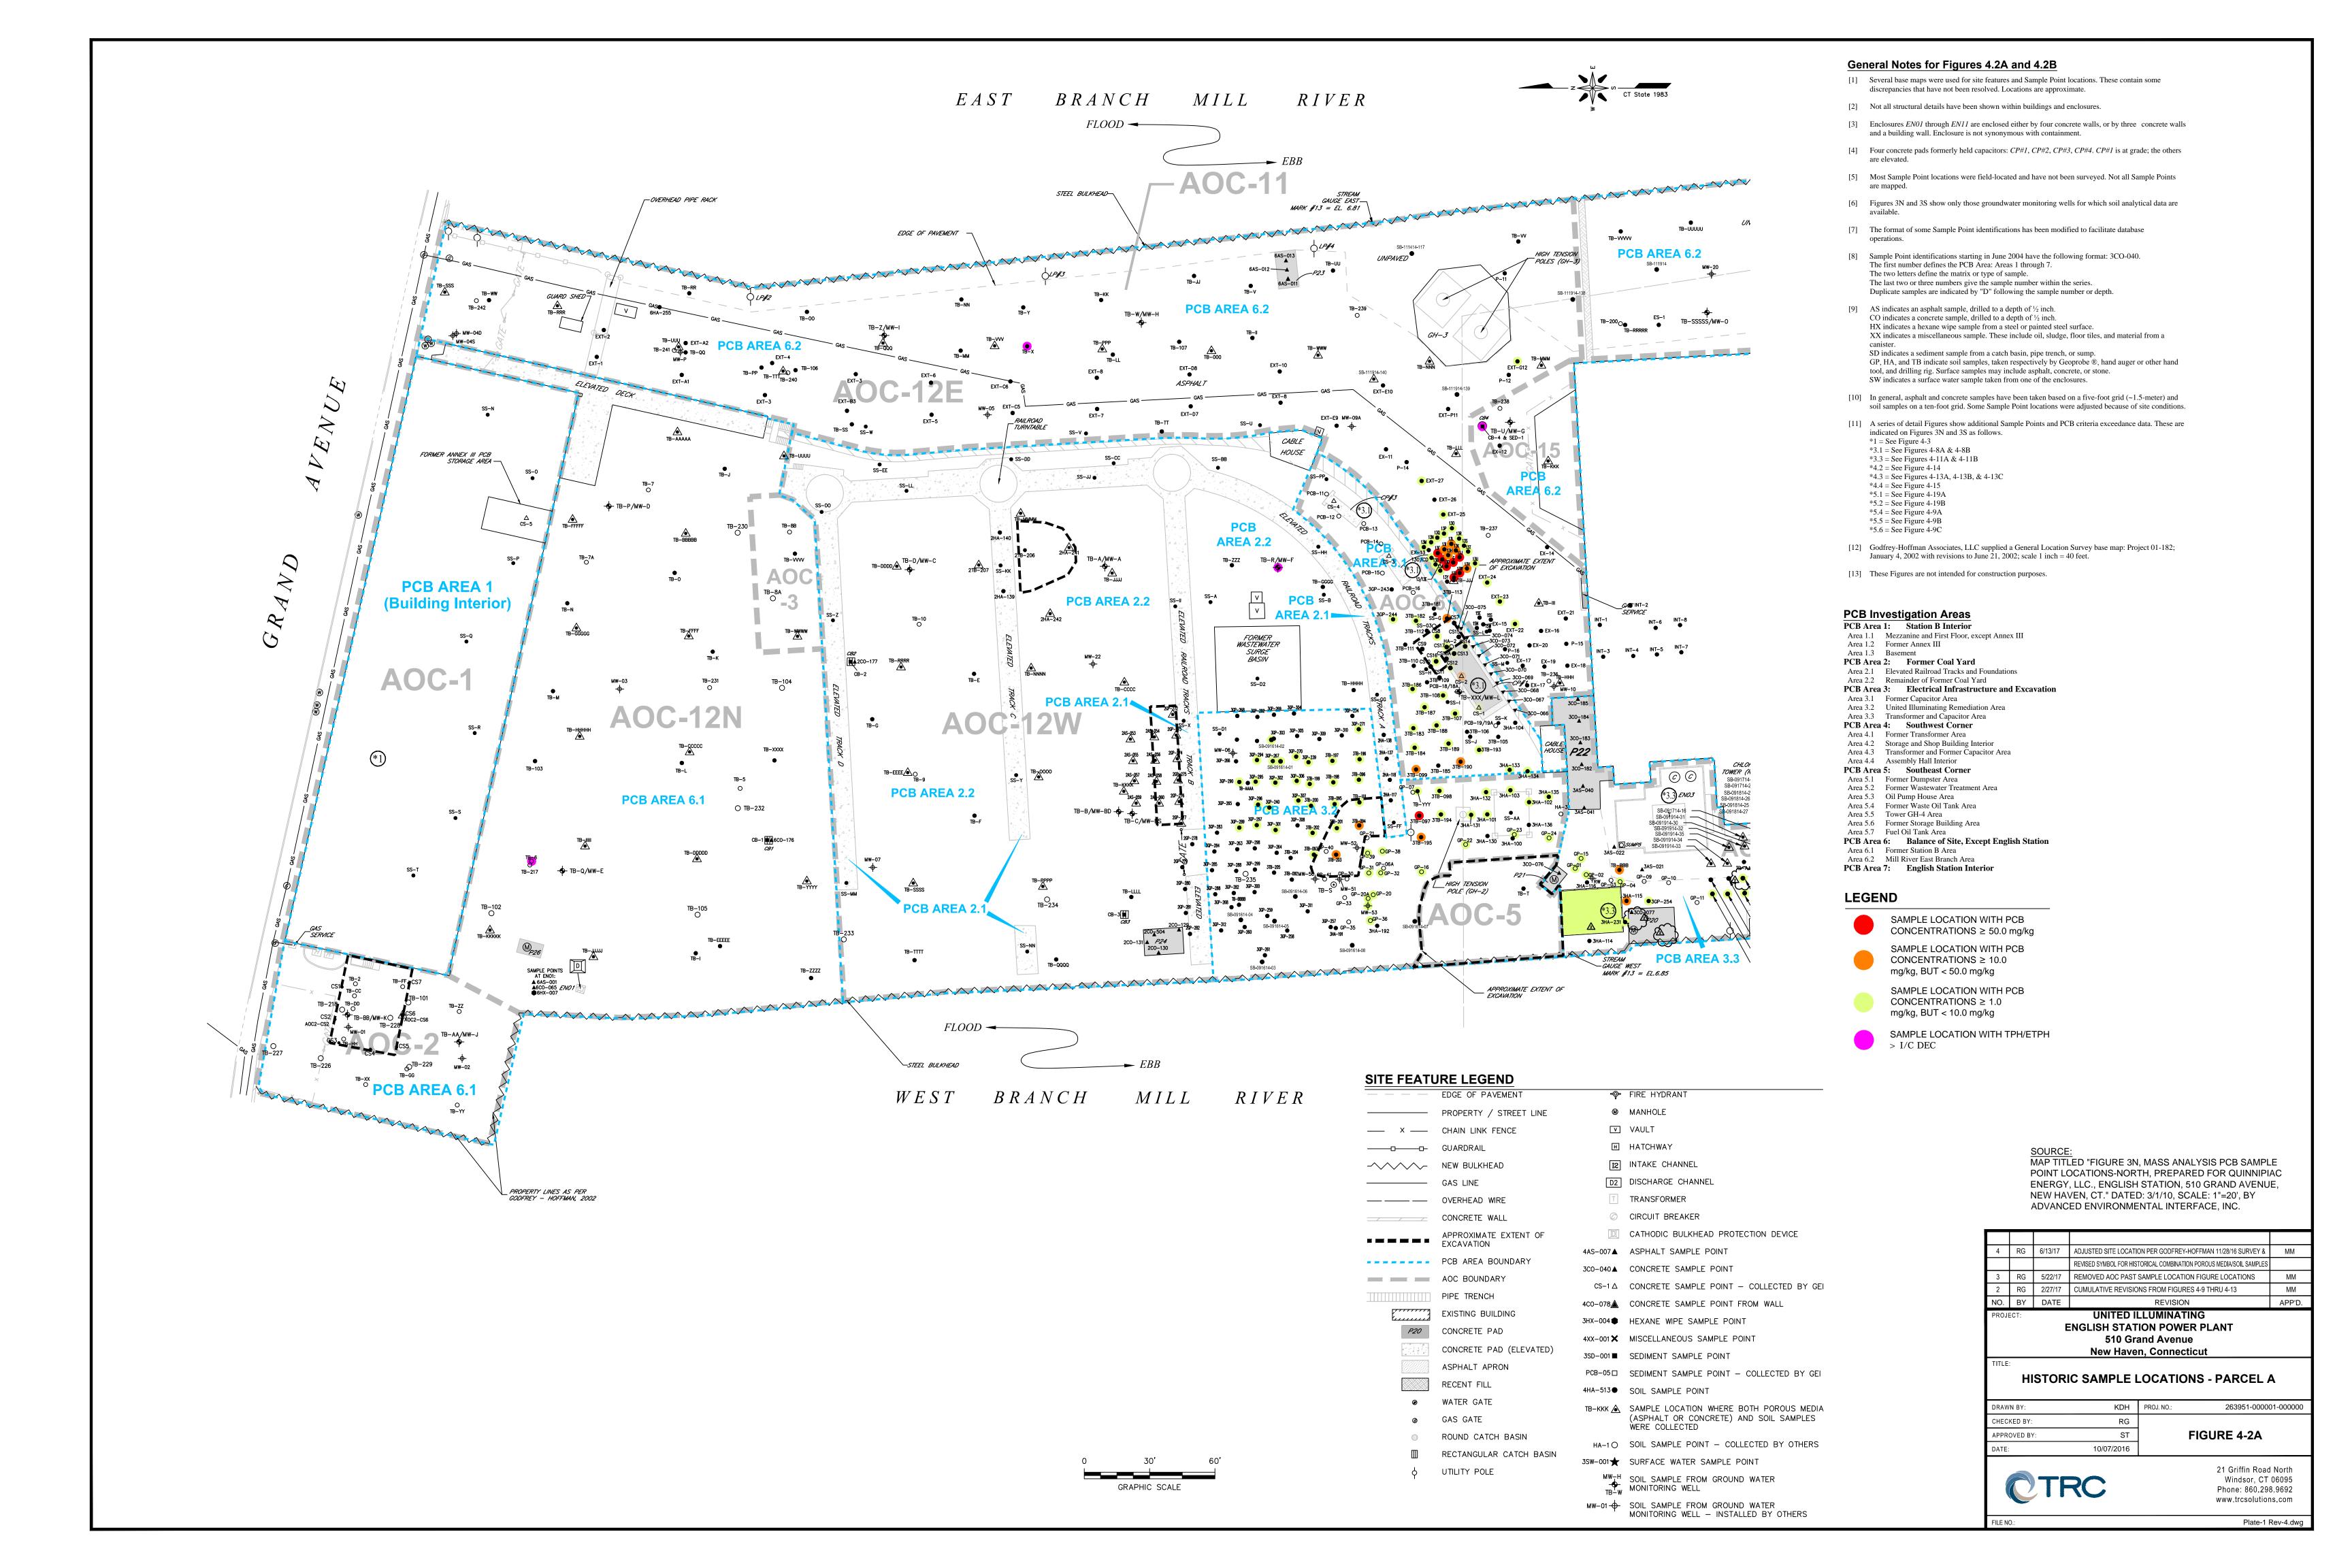

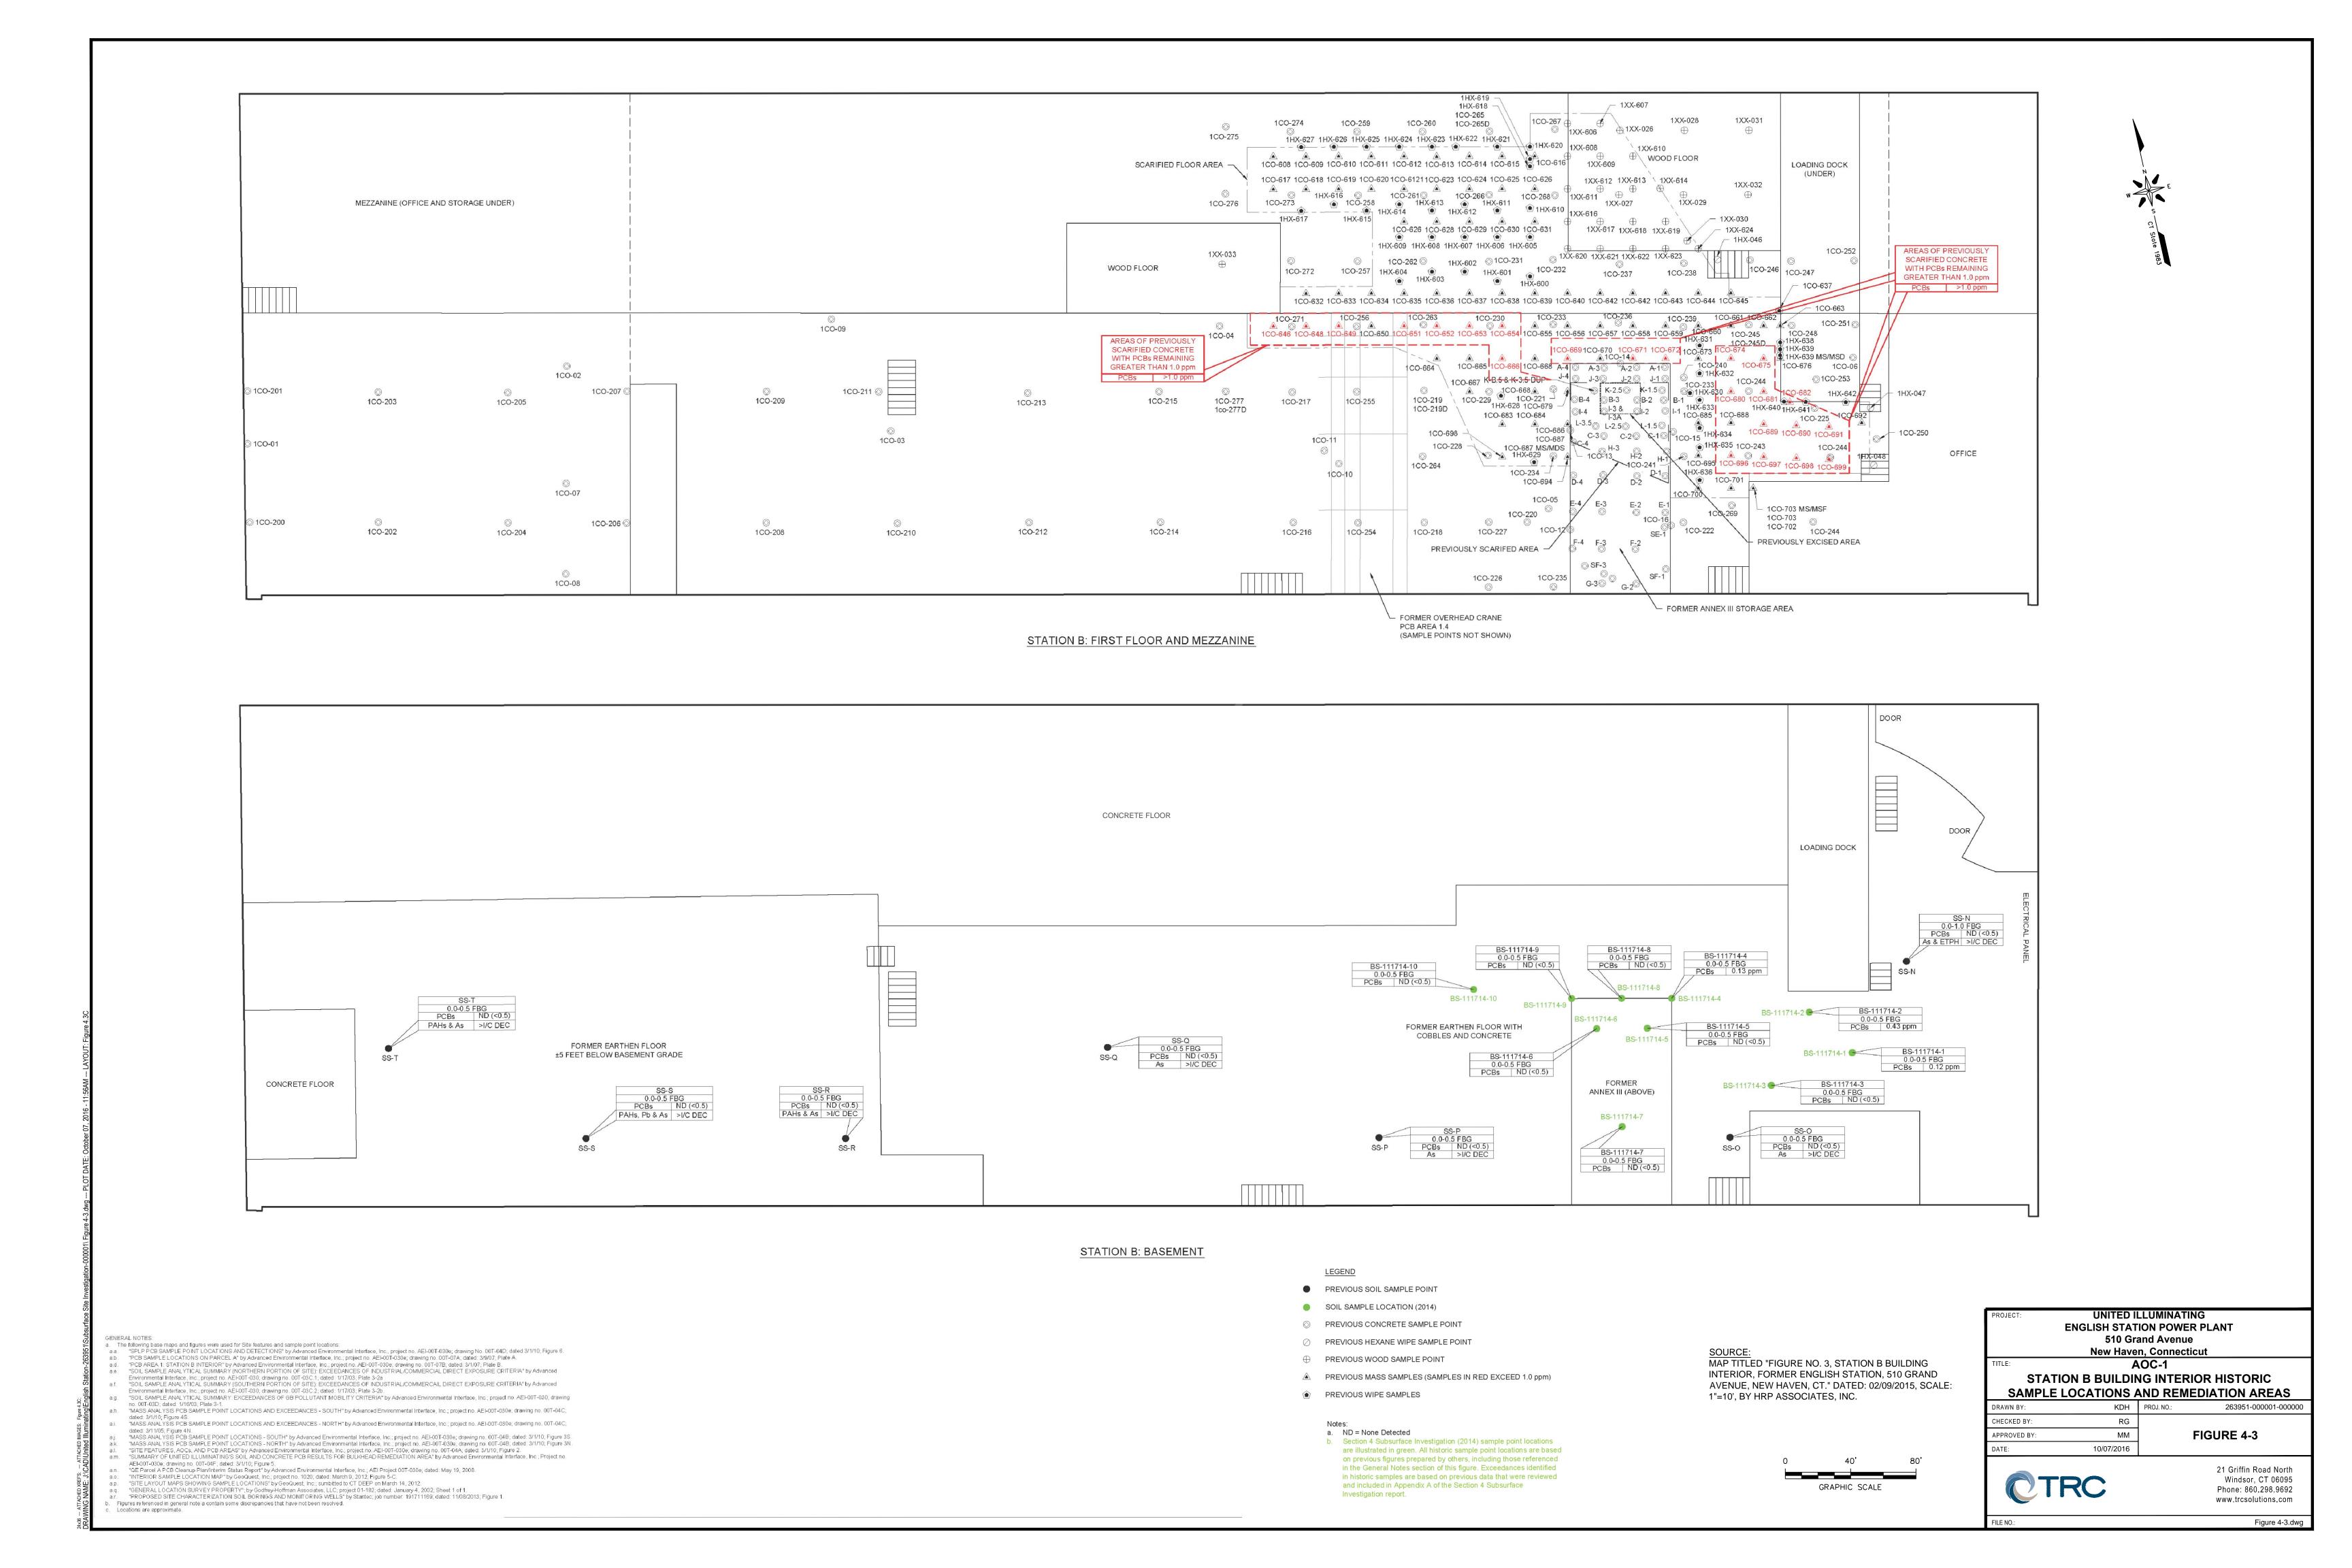

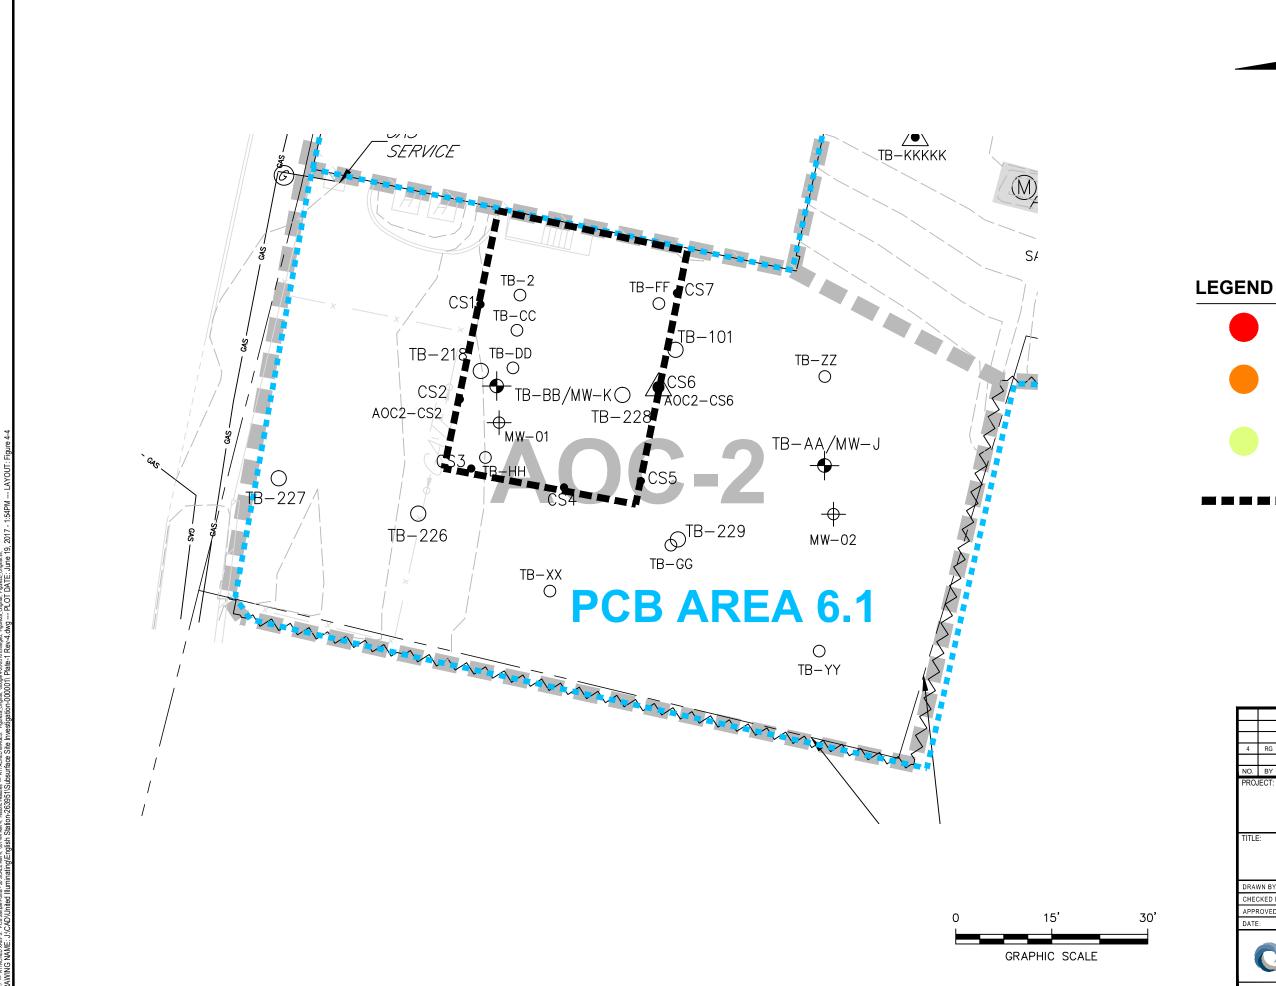

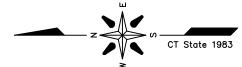

SAMPLE LOCATION WITH PCB CONCENTRATIONS ≥ 50.0 mg/kg



SAMPLE LOCATION WITH PCB CONCENTRATIONS ≥ 10.0 mg/kg, BUT < 50.0 mg/kg



SAMPLE LOCATION WITH PCB CONCENTRATIONS ≥ 1.0 mg/kg, BUT < 10.0 mg/kg



APPROXIMATE LIMIT OF EXCAVATION

NOTE:

SEE FIGURES 4-2A & 4-2B FOR NOTES, LEGEND AND LOCATION.

_				
4	RG	6/13/17	ADJUSTED SITE LOCATION PER GODFREY-HOFFMAN 11/28/16 SURVEY &	MM
			REVISED SYMBOL FOR HISTORICAL COMBINATION POROUS MEDIA/SOIL SAMPLES	
NO.	BY	DATE	REVISION	APP'D.
DDO	FOT			

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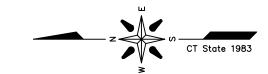
AOC-2 **HISTORIC SAMPLE LOCATIONS**


DRAWN BY:	KDH	PROJ NO.:	263951-000001-000000
CHECKED BY:	RG		
APPROVED BY:	MM		FIGURE 4-4
DATE:	01/04/2017		



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Plate-1 Rev-4.dwg



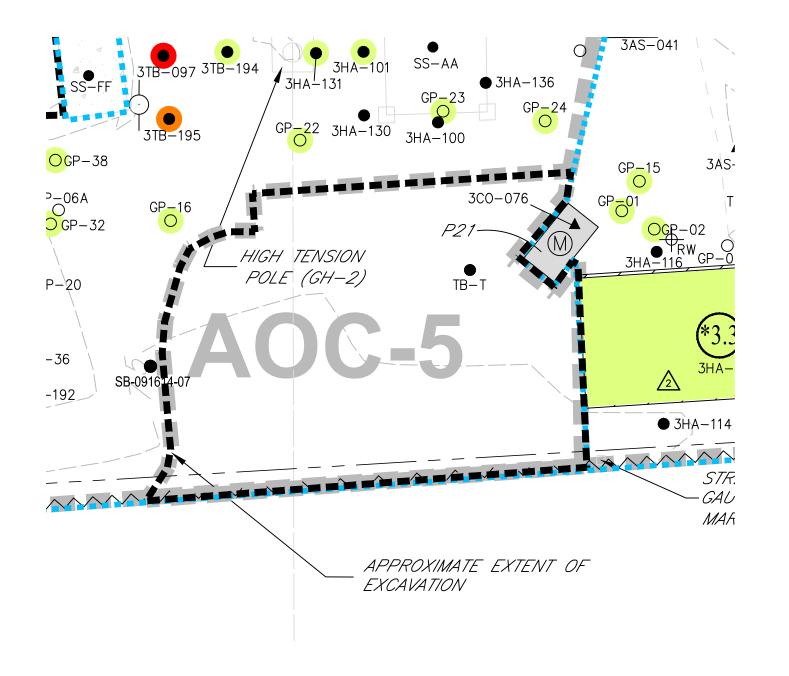

LEGEND

SAMPLE LOCATION WITH PCB CONCENTRATIONS ≥ 50.0 mg/kg



SAMPLE LOCATION WITH PCB CONCENTRATIONS ≥ 10.0 mg/kg, BUT < 50.0 mg/kg



SAMPLE LOCATION WITH PCB CONCENTRATIONS ≥ 1.0 mg/kg, BUT < 10.0 mg/kg



APPROXIMATE LIMIT OF EXCAVATION

NOTE: SEE FIGURES 4-2A & 4-2B FOR NOTES, LEGEND AND LOCATION.

4	RG	6/13/17	ADJUSTED SITE LOCATION PER GODFREY-HOFFMAN 11/28/16 SURVEY	MM
NO.	BY	DATE	REVISION	APP'D.
DDO	EOT			

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TITLE:


AOC-5 BULKHEAD PCB REMEDIATION AREA


DRAWN BY:	KDH	PROJ NO.:	263951-000001-000000
CHECKED BY:	RG		
APPROVED BY:	MM		FIGURE 4-7
DATE:	10/07/2016		



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Capacitor Pad #2

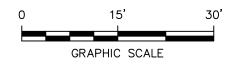



Figure A3.1c: PCB Area 3.1 - Concrete Sample

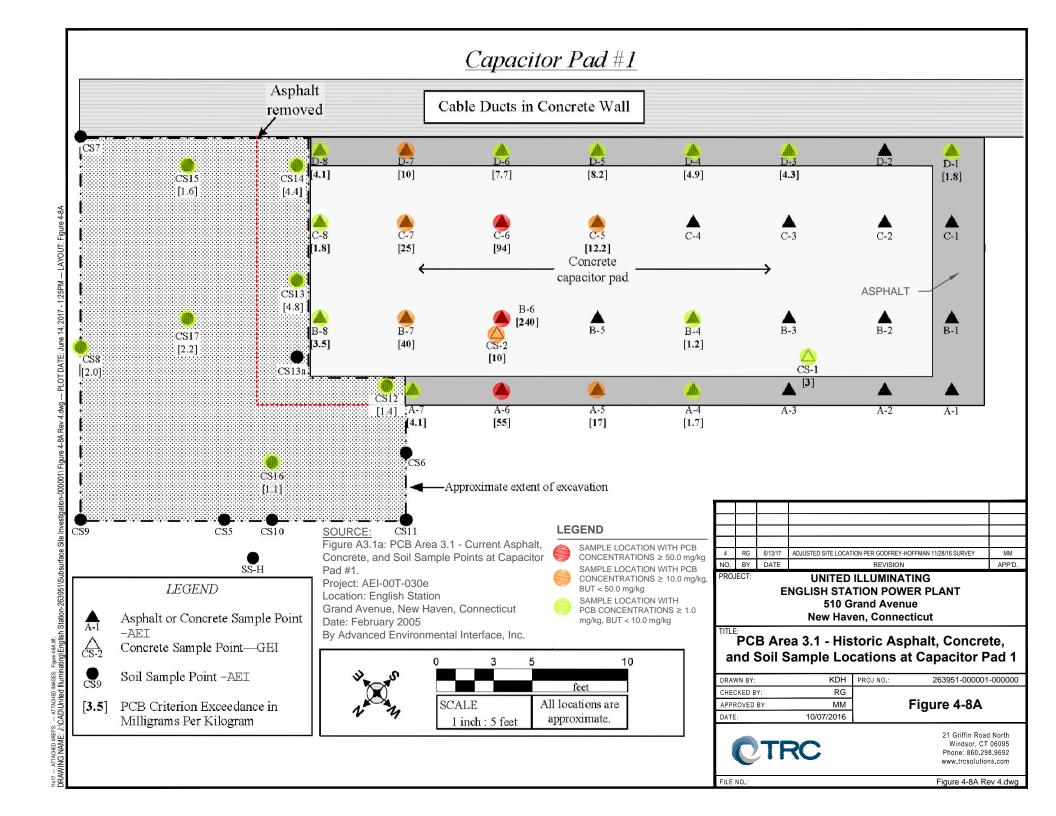Points at Capacitor Pads #2 & #3. Project: AEI-00T-030e Location: English Station

Grand Avenue, New Haven, Connecticut

Date: February 2005

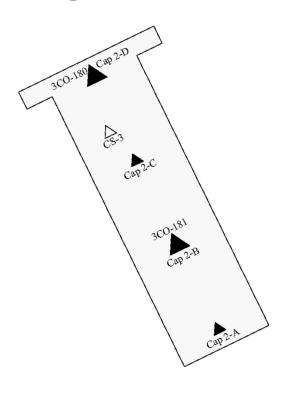By Advanced Environmental Interface, Inc.

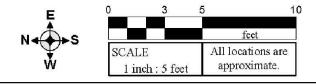

4	RG	6/13/17	ADJUSTED SITE LOCATION PER GODFREY-HOFFMAN 11/28/16 SURVEY	MM
NO.	BY	DATE	REVISION	APP'D.

PROJECT:

UNITED ILLUMINATING **ENGLISH STATION POWER PLANT** 510 Grand Avenue New Haven, Connecticut

PCB Area 3.1 - Historic Concrete Sample **Locations at Capacitor Pads 2 & 3**

DRAWN BY:	KDH	PROJ NO.:	263951-000001-000000
CHECKED BY:	RG		
APPROVED BY:	MM		Figure 4-8B
DATE:	10/07/2016		
	CHECKED BY: APPROVED BY:	CHECKED BY: RG APPROVED BY: MM	CHECKED BY: RG APPROVED BY: MM



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Figure 4-8B Rev 4.dwg

LEGEND


Cap 3-A Concrete Sample Point Concrete Sample Point-GEI CS-4


Cap 3-A


тил? — итмонер жеге». — итмонер мимсв. Figure 448 иff. DRAWING NAME: J.ICADIUnited IlluminatinglEnglish Station-263951/Subsurface Site Investigation-000001/Figure 4-8B Rev 4.dwg.


3CO-180

Concrete Sample Point-Adjacent

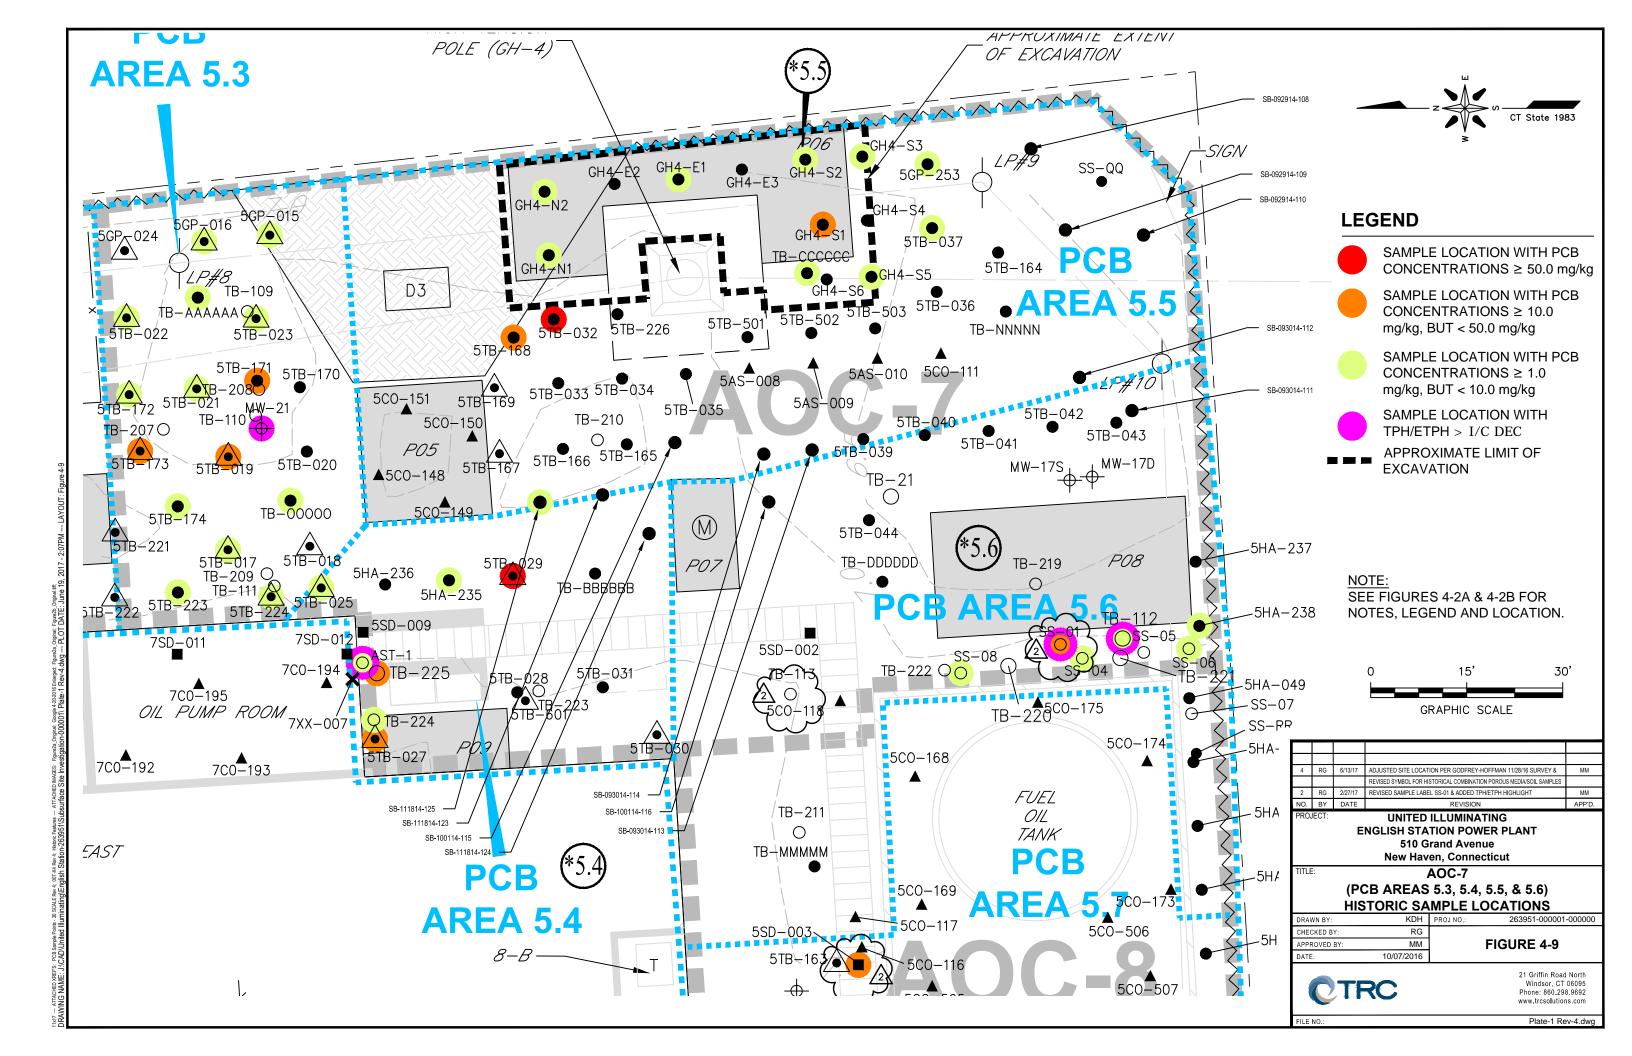

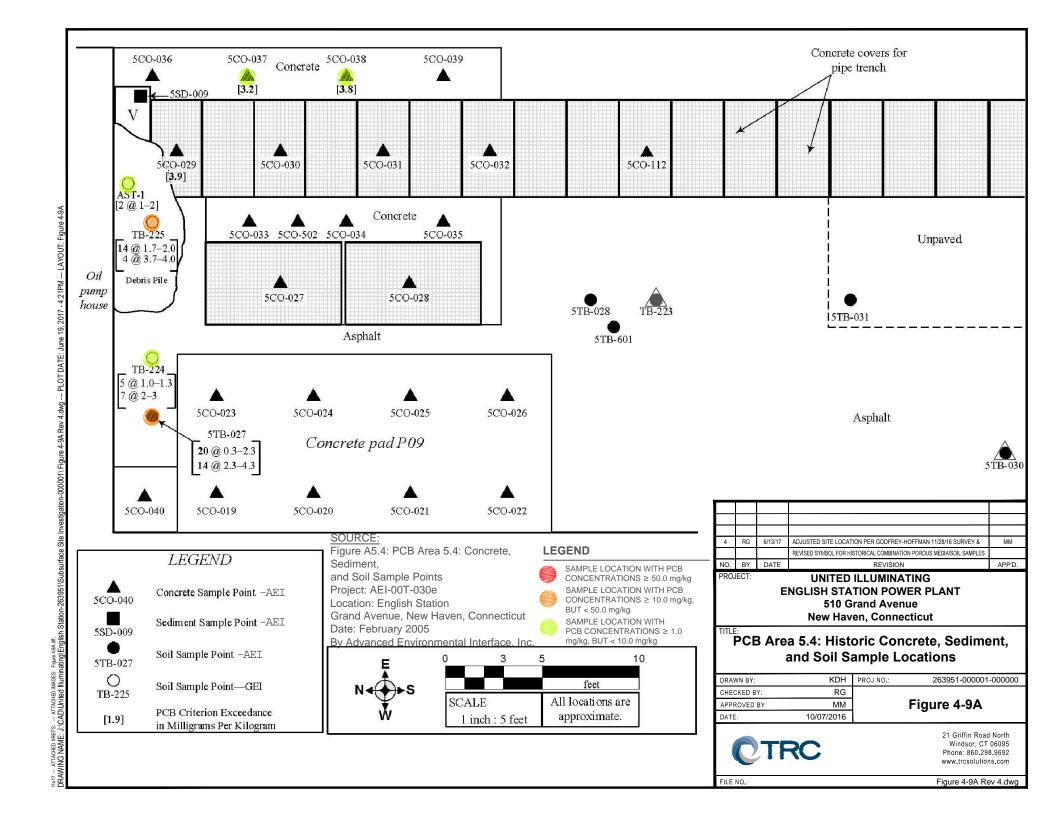

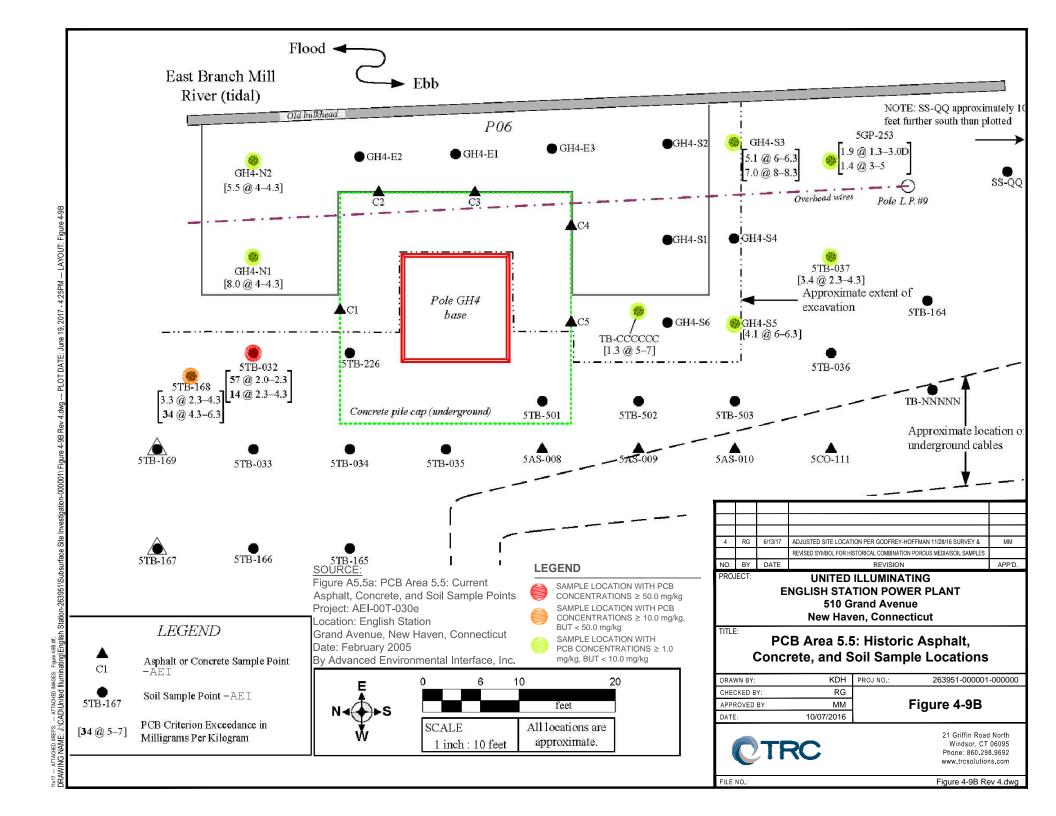

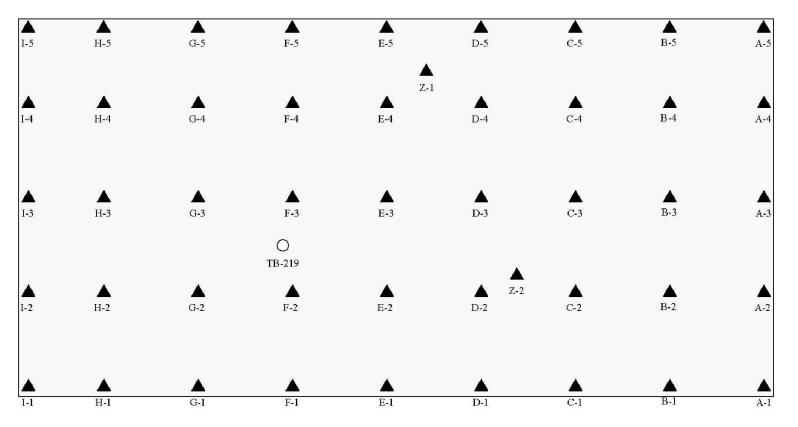


SOURCE:

Figure A5.6: PCB Area 5.6: Concrete and Soil Sample Points at Concrete Pad P08 Project: AEI-00T-030e Location: English Station Grand Avenue, New Haven, Connecticut

Date: February 2005

By Advanced Environmental Interface, Inc.

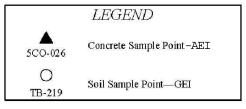

E	0	3	5	<u>1</u> 0
N.A.				feet
	SCALE			locations are
yv	l inch	n : 5 fee	t l a	pproximate.

4	RG	6/13/17	ADJUSTED SITE LOCATION PER GODFREY-HOFFMAN 11/28/16 SURVEY	MM
NO.	BY	DATE	REVISION	APP'D.

PROJECT: UNITED ILLUMINATING
ENGLISH STATION POWER PLANT
510 Grand Avenue
New Haven, Connecticut

PCB Area 5.6: Historic Concrete and Soil Sample Locations at Concrete Pad P08


DRAWN BY:	KDH	PROJ NO.:	263951-000001-000000
CHECKED BY:	RG		
APPROVED BY:	MM		Figure 4-9C
DATE:	10/07/2016		<u> </u>



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No.: Figure 4-9C Rev 4.dwg

Plate-1 Rev-4.dwg

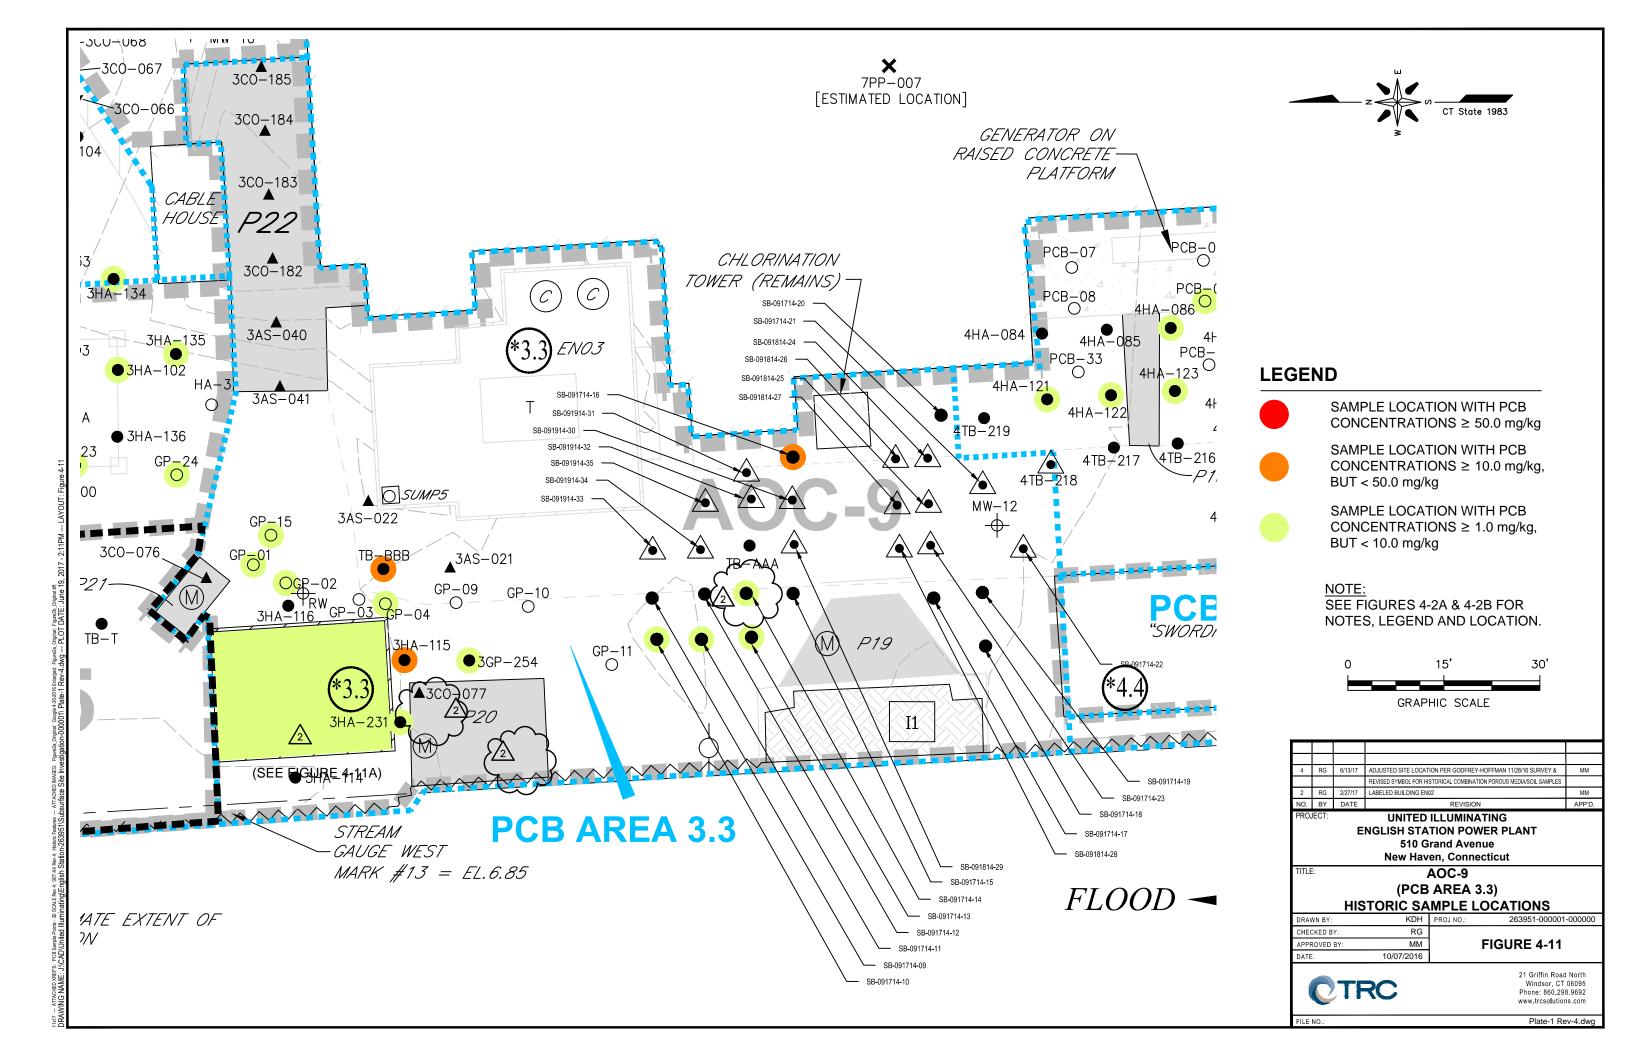

NOTES:

- 1. Hexane wipe samples were taken from an elevated steel deck above the enclosure concrete floor.
- 2. Many enclosure details are not shown.

SOURCE:

Figure A3.3a: PCB Area 3.3: Concrete, Hexane Wipe, and Sediment Sample Points at Enclosure EN02.

Project: AEI-00T-030e Location: English Station Grand Avenue, New Haven, Connecticut

Date: February 2005

By Advanced Environmental Interface, Inc.

LEGEND

SAMPLE LOCATION WITH PCB CONCENTRATIONS ≥ 50.0 mg/kg SAMPLE LOCATION WITH PCB CONCENTRATIONS ≥ 10.0 mg/kg, BUT < 50.0 mg/kg

SAMPLE LOCATION WITH PCB CONCENTRATIONS ≥ 1.0

mg/kg, BUT < 10.0 mg/kg

6/13/17 ADJUSTED SITE LOCATION PER GODFREY-HOFFMAN 11/28/16 SURVEY RG 2/27/17 REV PCB-06 LABEL NO. BY DATE REVISION APP'D. UNITED ILLUMINATING

ENGLISH STATION POWER PLANT 510 Grand Avenue New Haven, Connecticut

PCB Area 3.3: Historic Concrete, **Hexane Wipe, and Sediment Sample** Locations at Enclosure EN02

	=00000000000000000000000000000000000000	<u></u>	
DRAWN BY:	KDH	PROJ NO.:	263951-000001-000000
CHECKED BY:	RG		
APPROVED BY:	MM		Figure 4-11A
DATE:	10/07/2016		•



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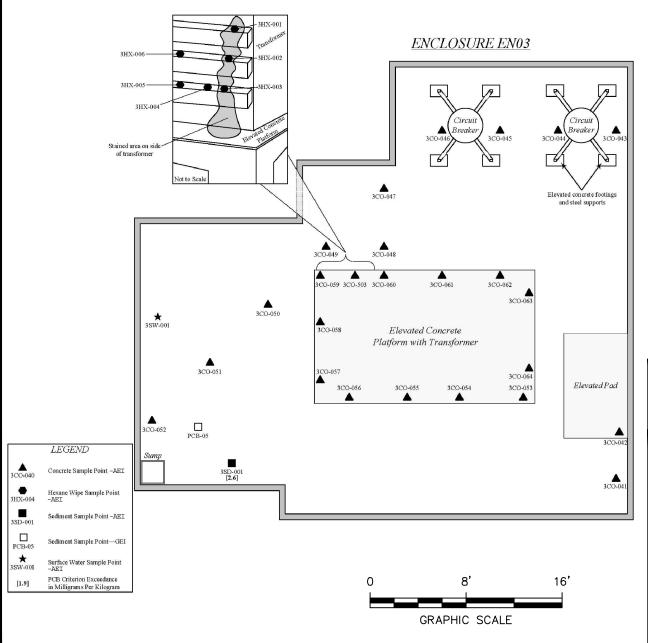
Figure 4-11A Rev 4.dwg

Concrete Sample Point -AEI Hexane Wipe Sample Point -AEI PCB-6 Sediment Sample Point-GEI PCB Criterion Exceedance in [1.9] Milligrams per Kilogram

LEGEND

5 10 feet SCALE All locations are approximate. 1 inch: 5 feet





263951\Subsurface Site Investigation-000001\Figure 4-11B Rev 4.dwg --- PLOT DATE: June 14, 2017 - 3:21PM -- LAYOUT: Figure 4.11B

11x17 — ATTACHED XREPS: — ATTACHED IMAGES: DRAWING NAME: J:\CAD\United Illumin

NOTES:

- 1. 3HX-004 was taken from area of intermediate staining.
- 2. Transformer has blue sticker indicating fluid contains less than 50 ppm PCB.
- 3. Elevated circuit breakers have green stickers indicating fluid contains less than 1 ppm PCB.
- 4. Many enclosure details are not shown.
- 5. All Locations Are Approximate.

SOURCE:

Figure A3.3b: PCB Area 3.3: Concrete, Hexane Wipe, Sediment, and Surface Water Sample Points at

Enclosure EN03. Project: AEI-00T-030e

Location: English Station

Grand Avenue, New Haven, Connecticut

Date: February 2005

By Advanced Environmental Interface, Inc.

All Locations Are Approximate

4	RG	6/13/17	ADJUSTED SITE LOCATION PER GODFREY-HOFFMAN 11/28/16 SURVEY	MM
NO.	BY	DATE	REVISION	APP'D.

PROJECT:

UNITED ILLUMINATING ENGLISH STATION POWER PLANT 510 Grand Avenue New Haven, Connecticut

PCB Area 3.3: Historic Concrete, Hexane Wipe, Sediment, and Surface Water Sample Locations at Enclosure EN03

DRAWN BY:	KDH	PROJ NO.:	263951-000001-000000
CHECKED BY:	RG		
APPROVED BY:	MM]	Figure 4-11B
DATE:	10/07/2016		J



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NO.: Figure 4-11B Rev 4.dwg

