


NOTE:
REVISION 4 INCLUDES A
PROPERTY LINE ADJUSTMENT
BASED ON THE 11/28/16 SURVEY
BY GODFREY-HOFFMAN &
ASSOC.

4 RG 6/13/17 ADJUSTED SITE LOCATION PER GODFREY-HOFFMAN 11/28/16 SURVEY MM NO. BY DATE REVISION APP'D. PROJECT: UNITED ILLUMINATING ENGLISH STATION POWER PLANT 510 Grand Avenue

SOURCE:

- MAP TITLED "FIGURE 3N, MASS ANALYSIS PCB SAMPLE POINT LOCATIONS-NORTH, PREPARED FOR QUINNIPIAC ENERGY, LLC., ENGLISH STATION, 510 GRAND AVENUE, NEW HAVEN, CT." DATED: 3/1/10, SCALE: 1"=20', BY ADVANCED ENVIRONMENTAL INTERFACE, INC.
- AERIAL IMAGE FROM GOOGLE EARTH PRO, DATE OF IMAGE: 04/20/2016

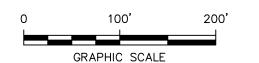

SITE PLAN AND APPROXIMATE PARCEL BOUNDARIES


New Haven, Connecticut


| DRAWN BY: | KDH | PROJ NO.: | 263951-000001-000000 |
|--------------|------------|-----------|----------------------|
| CHECKED BY: | RG | | |
| APPROVED BY: | MM | | FIGURE 2-1 |
| DATE: | 10/07/2016 | | |





21 Griffin Road North Windsor, CT 06095 Phone: 860.298.9692 www.trcsolutions.com


Plate-1 Rev-4.dwg

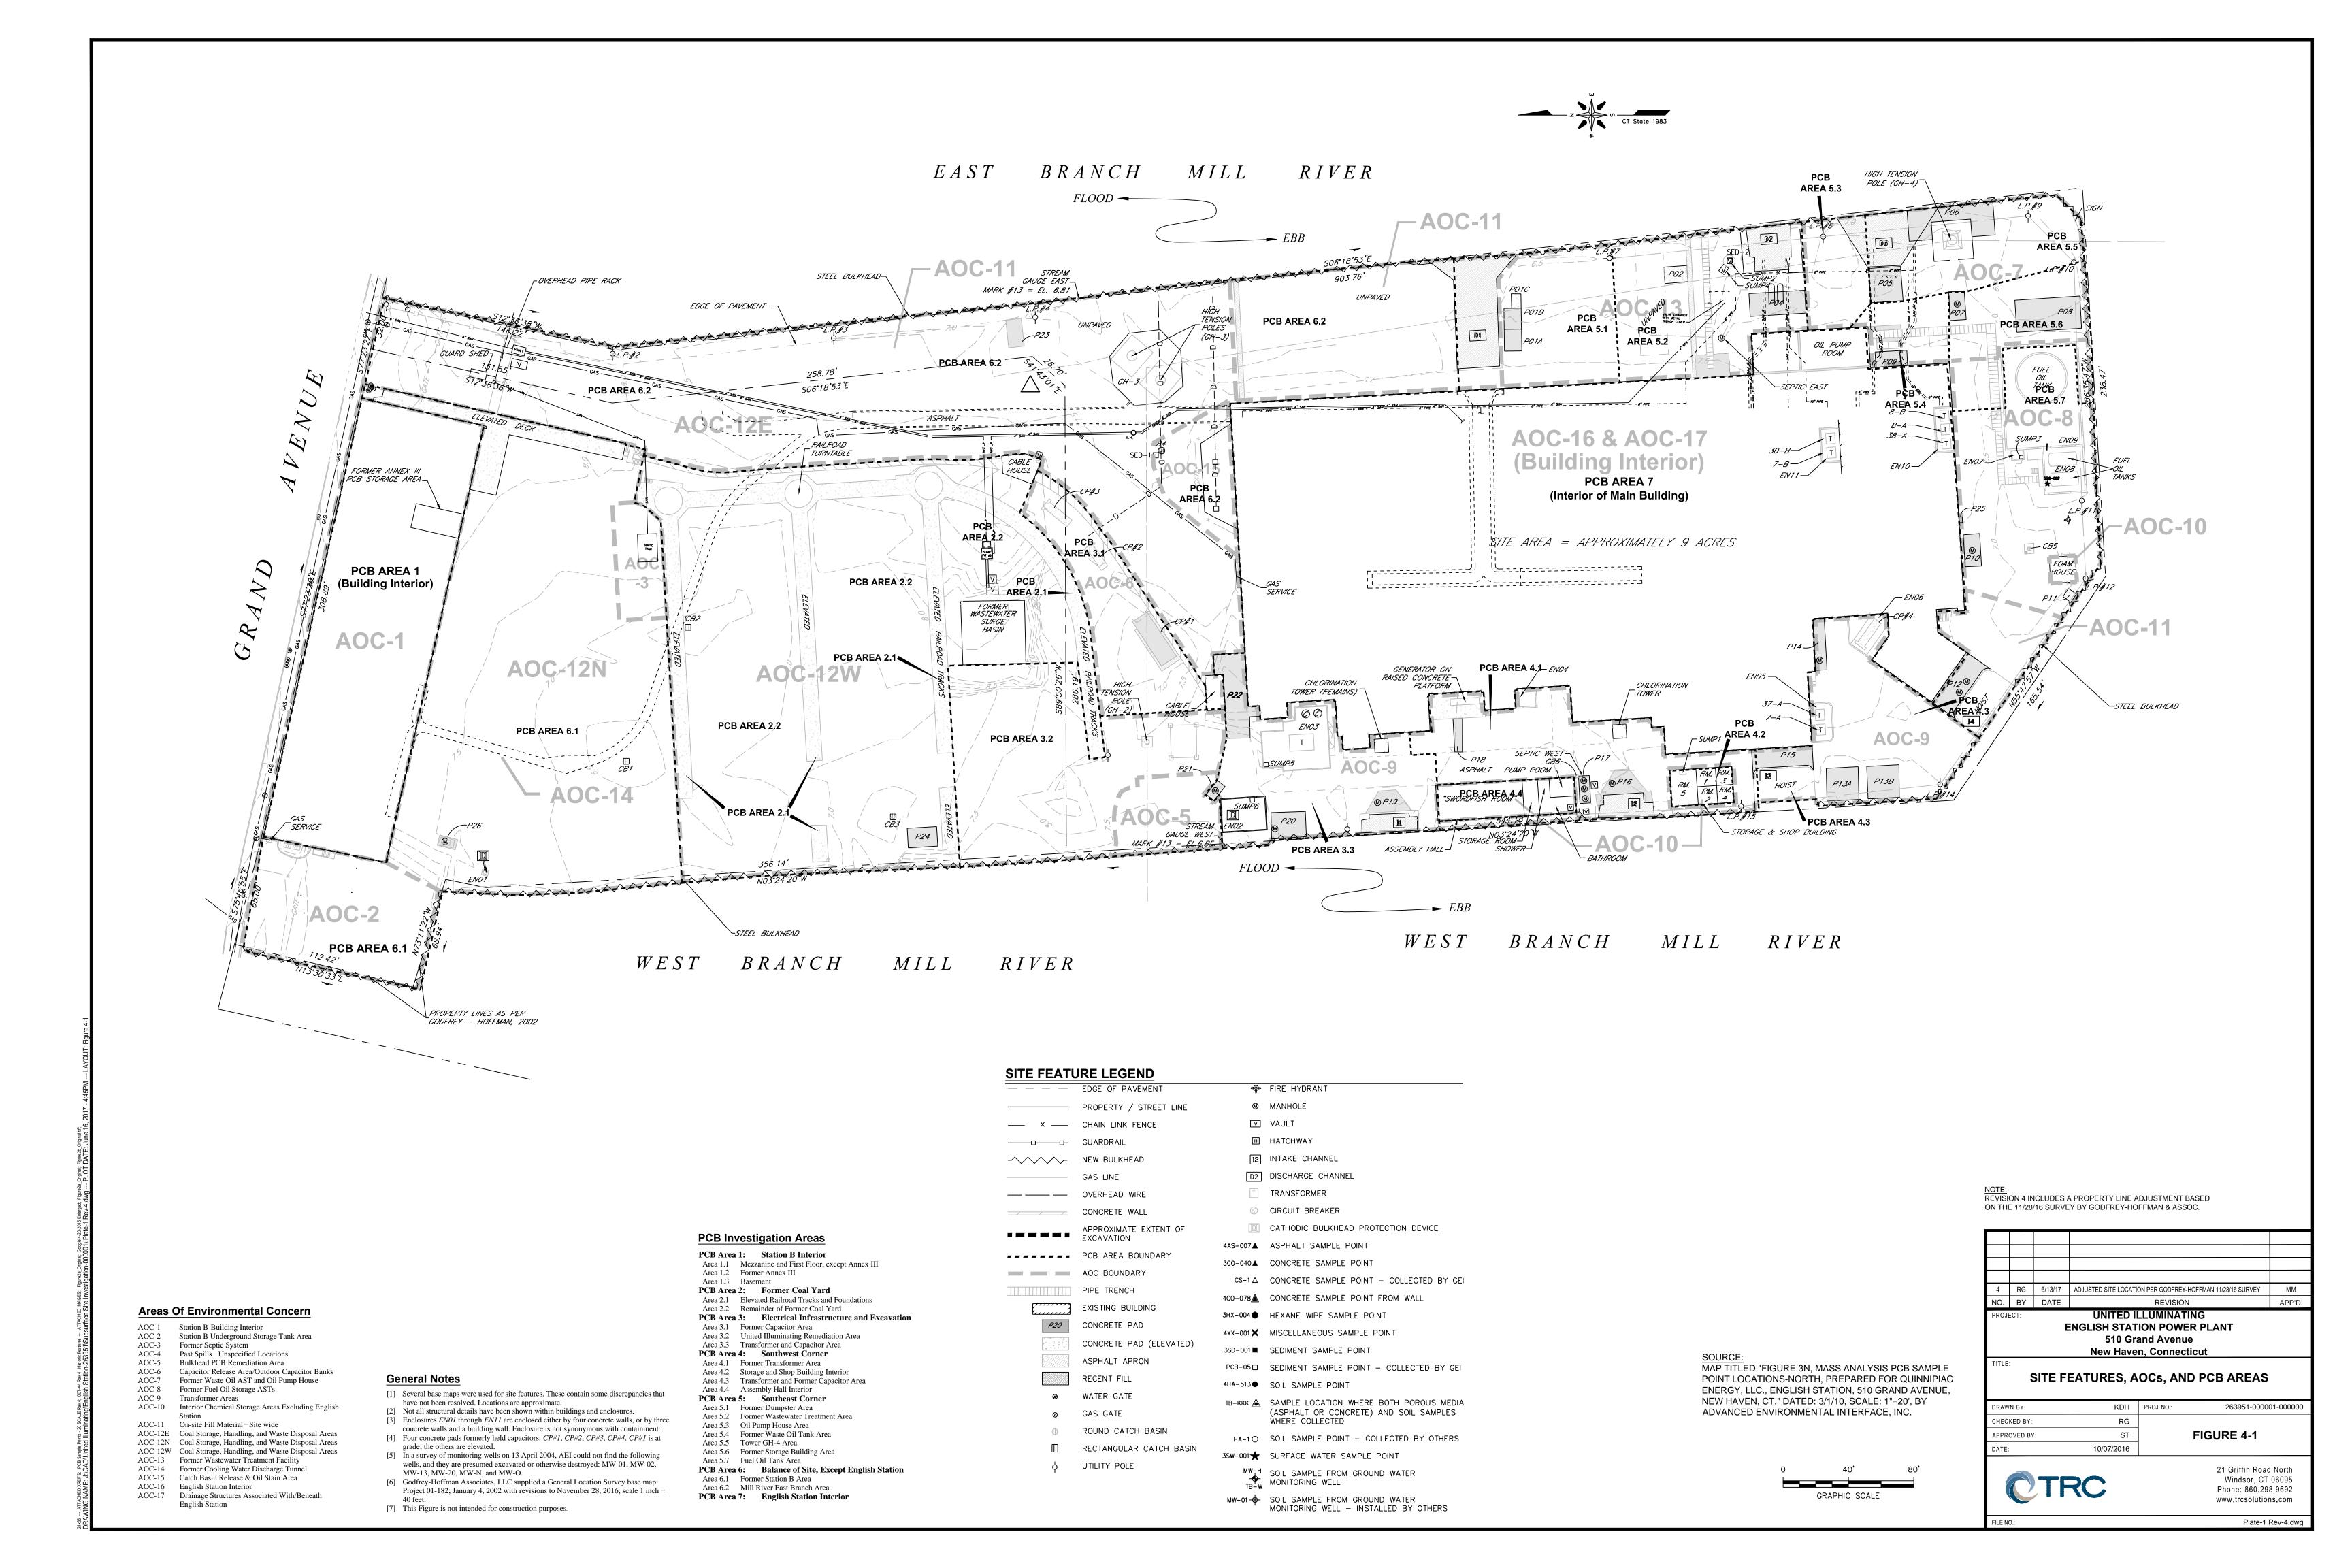


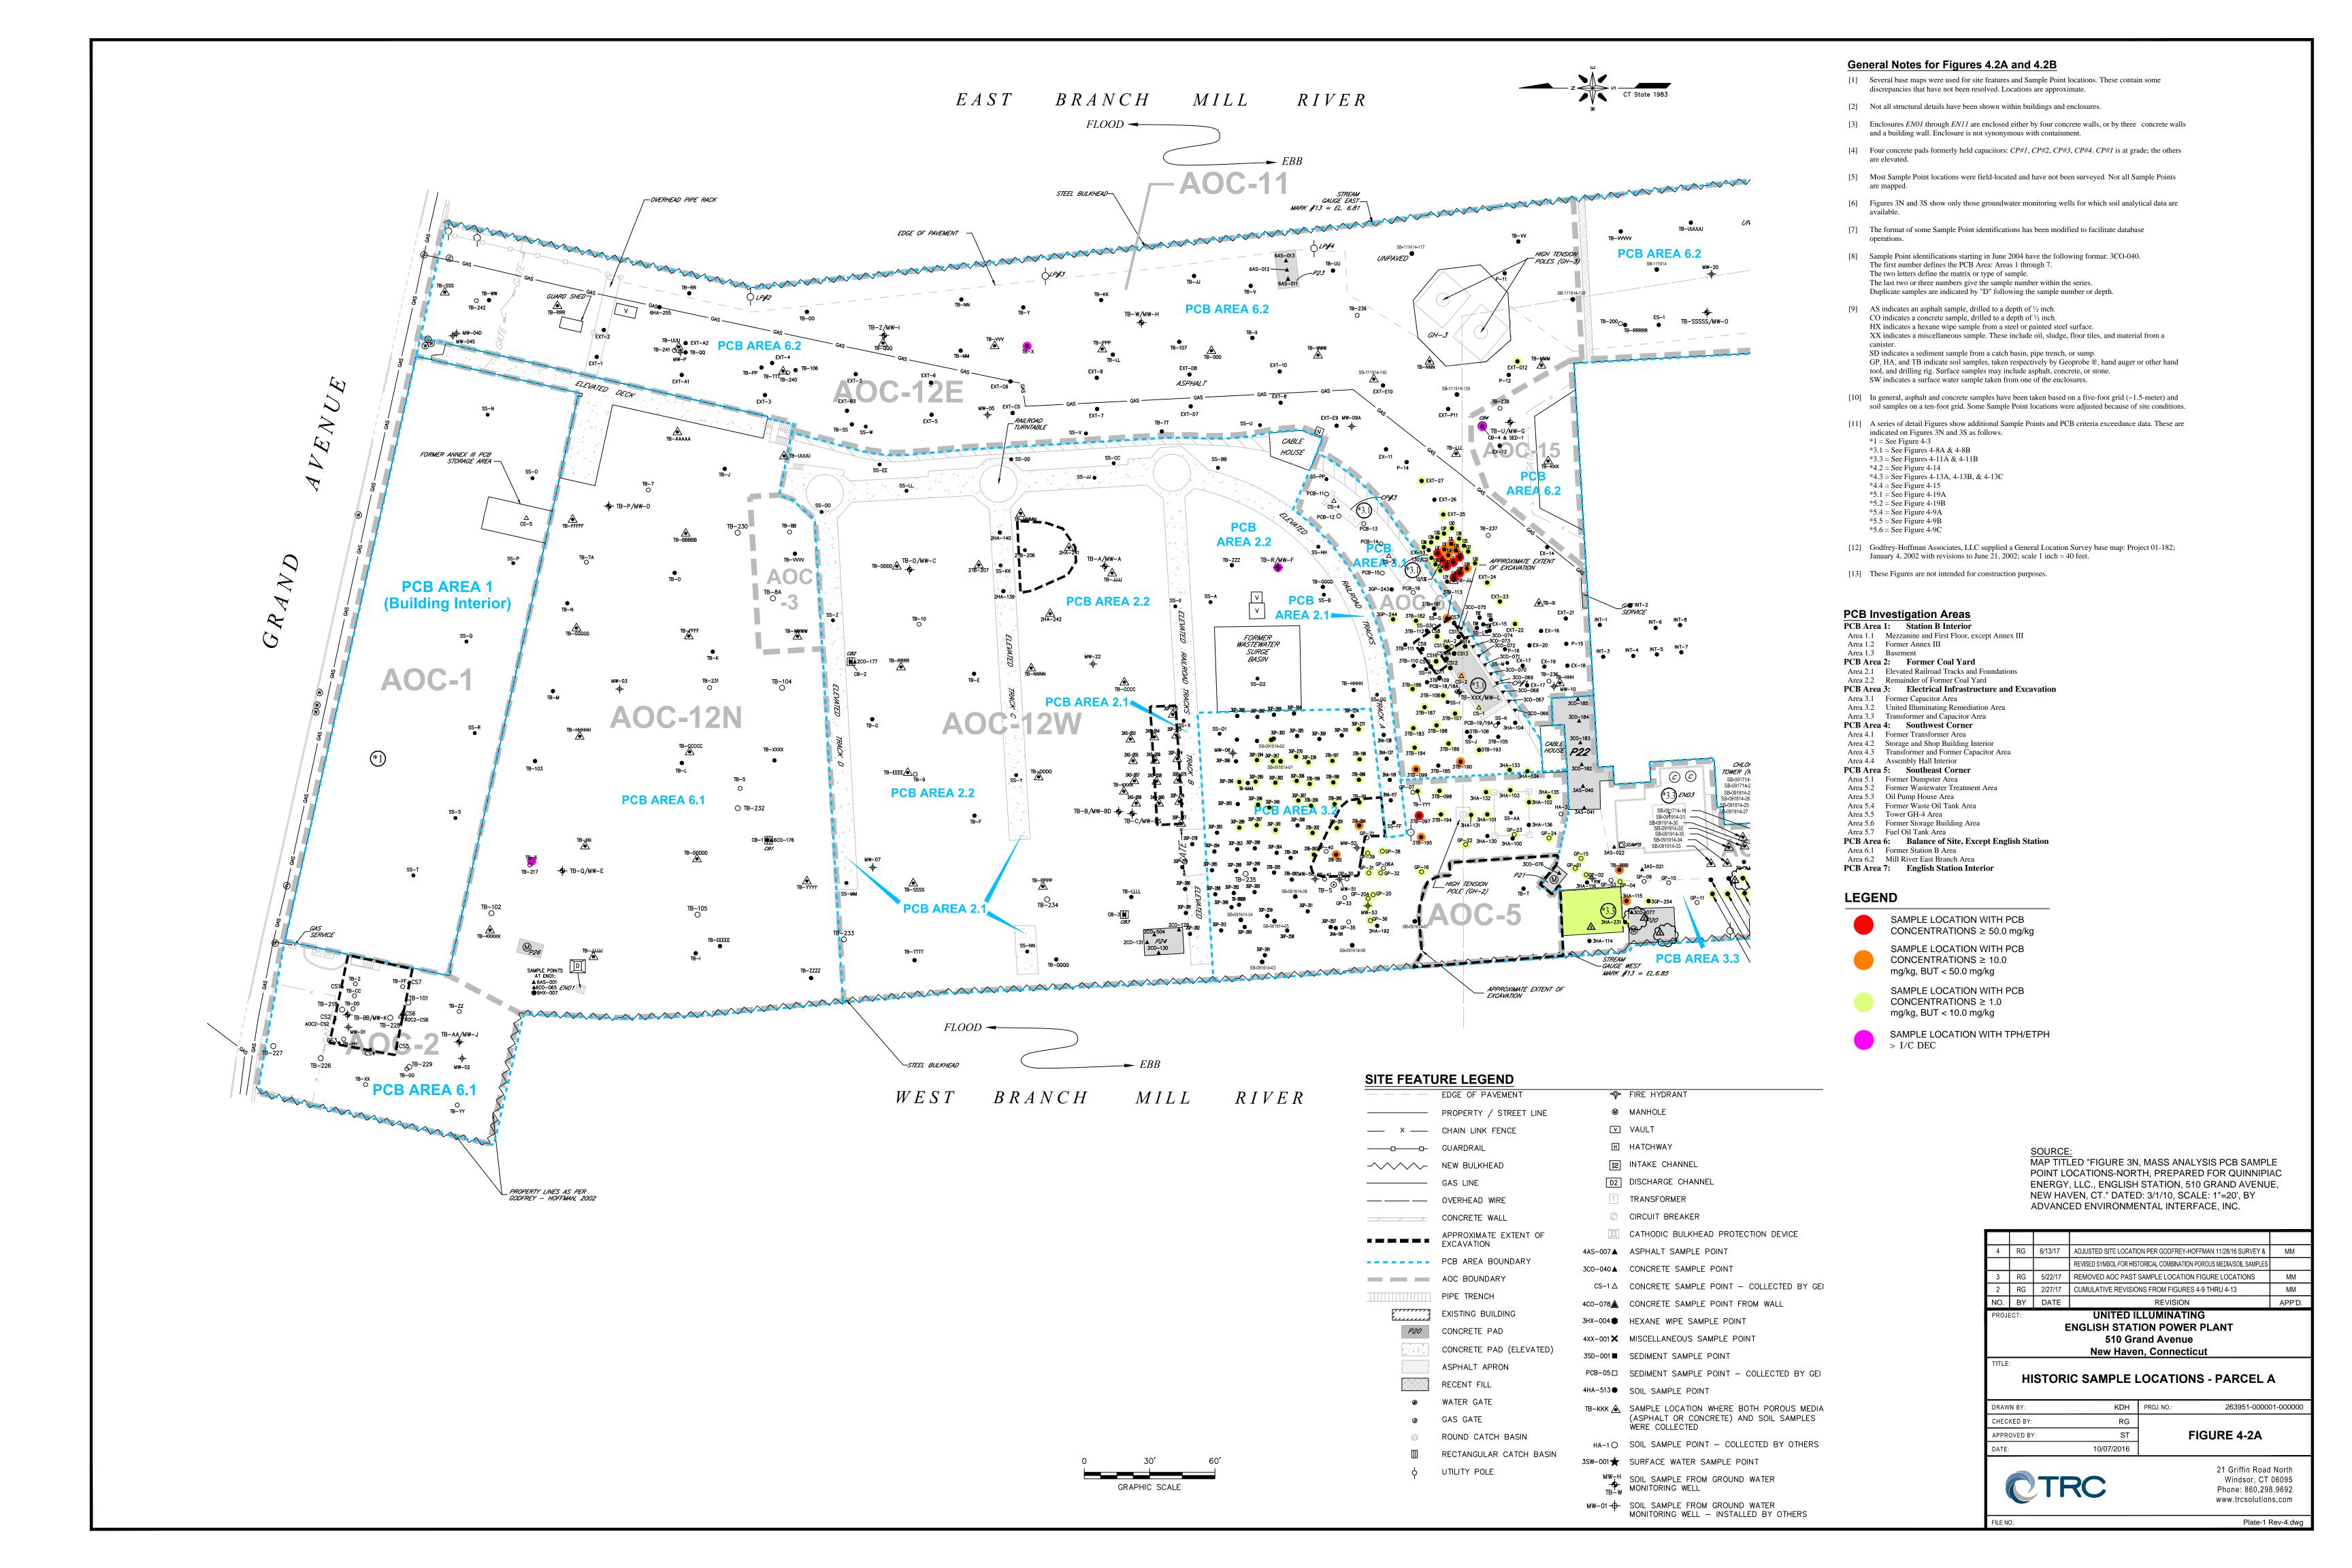

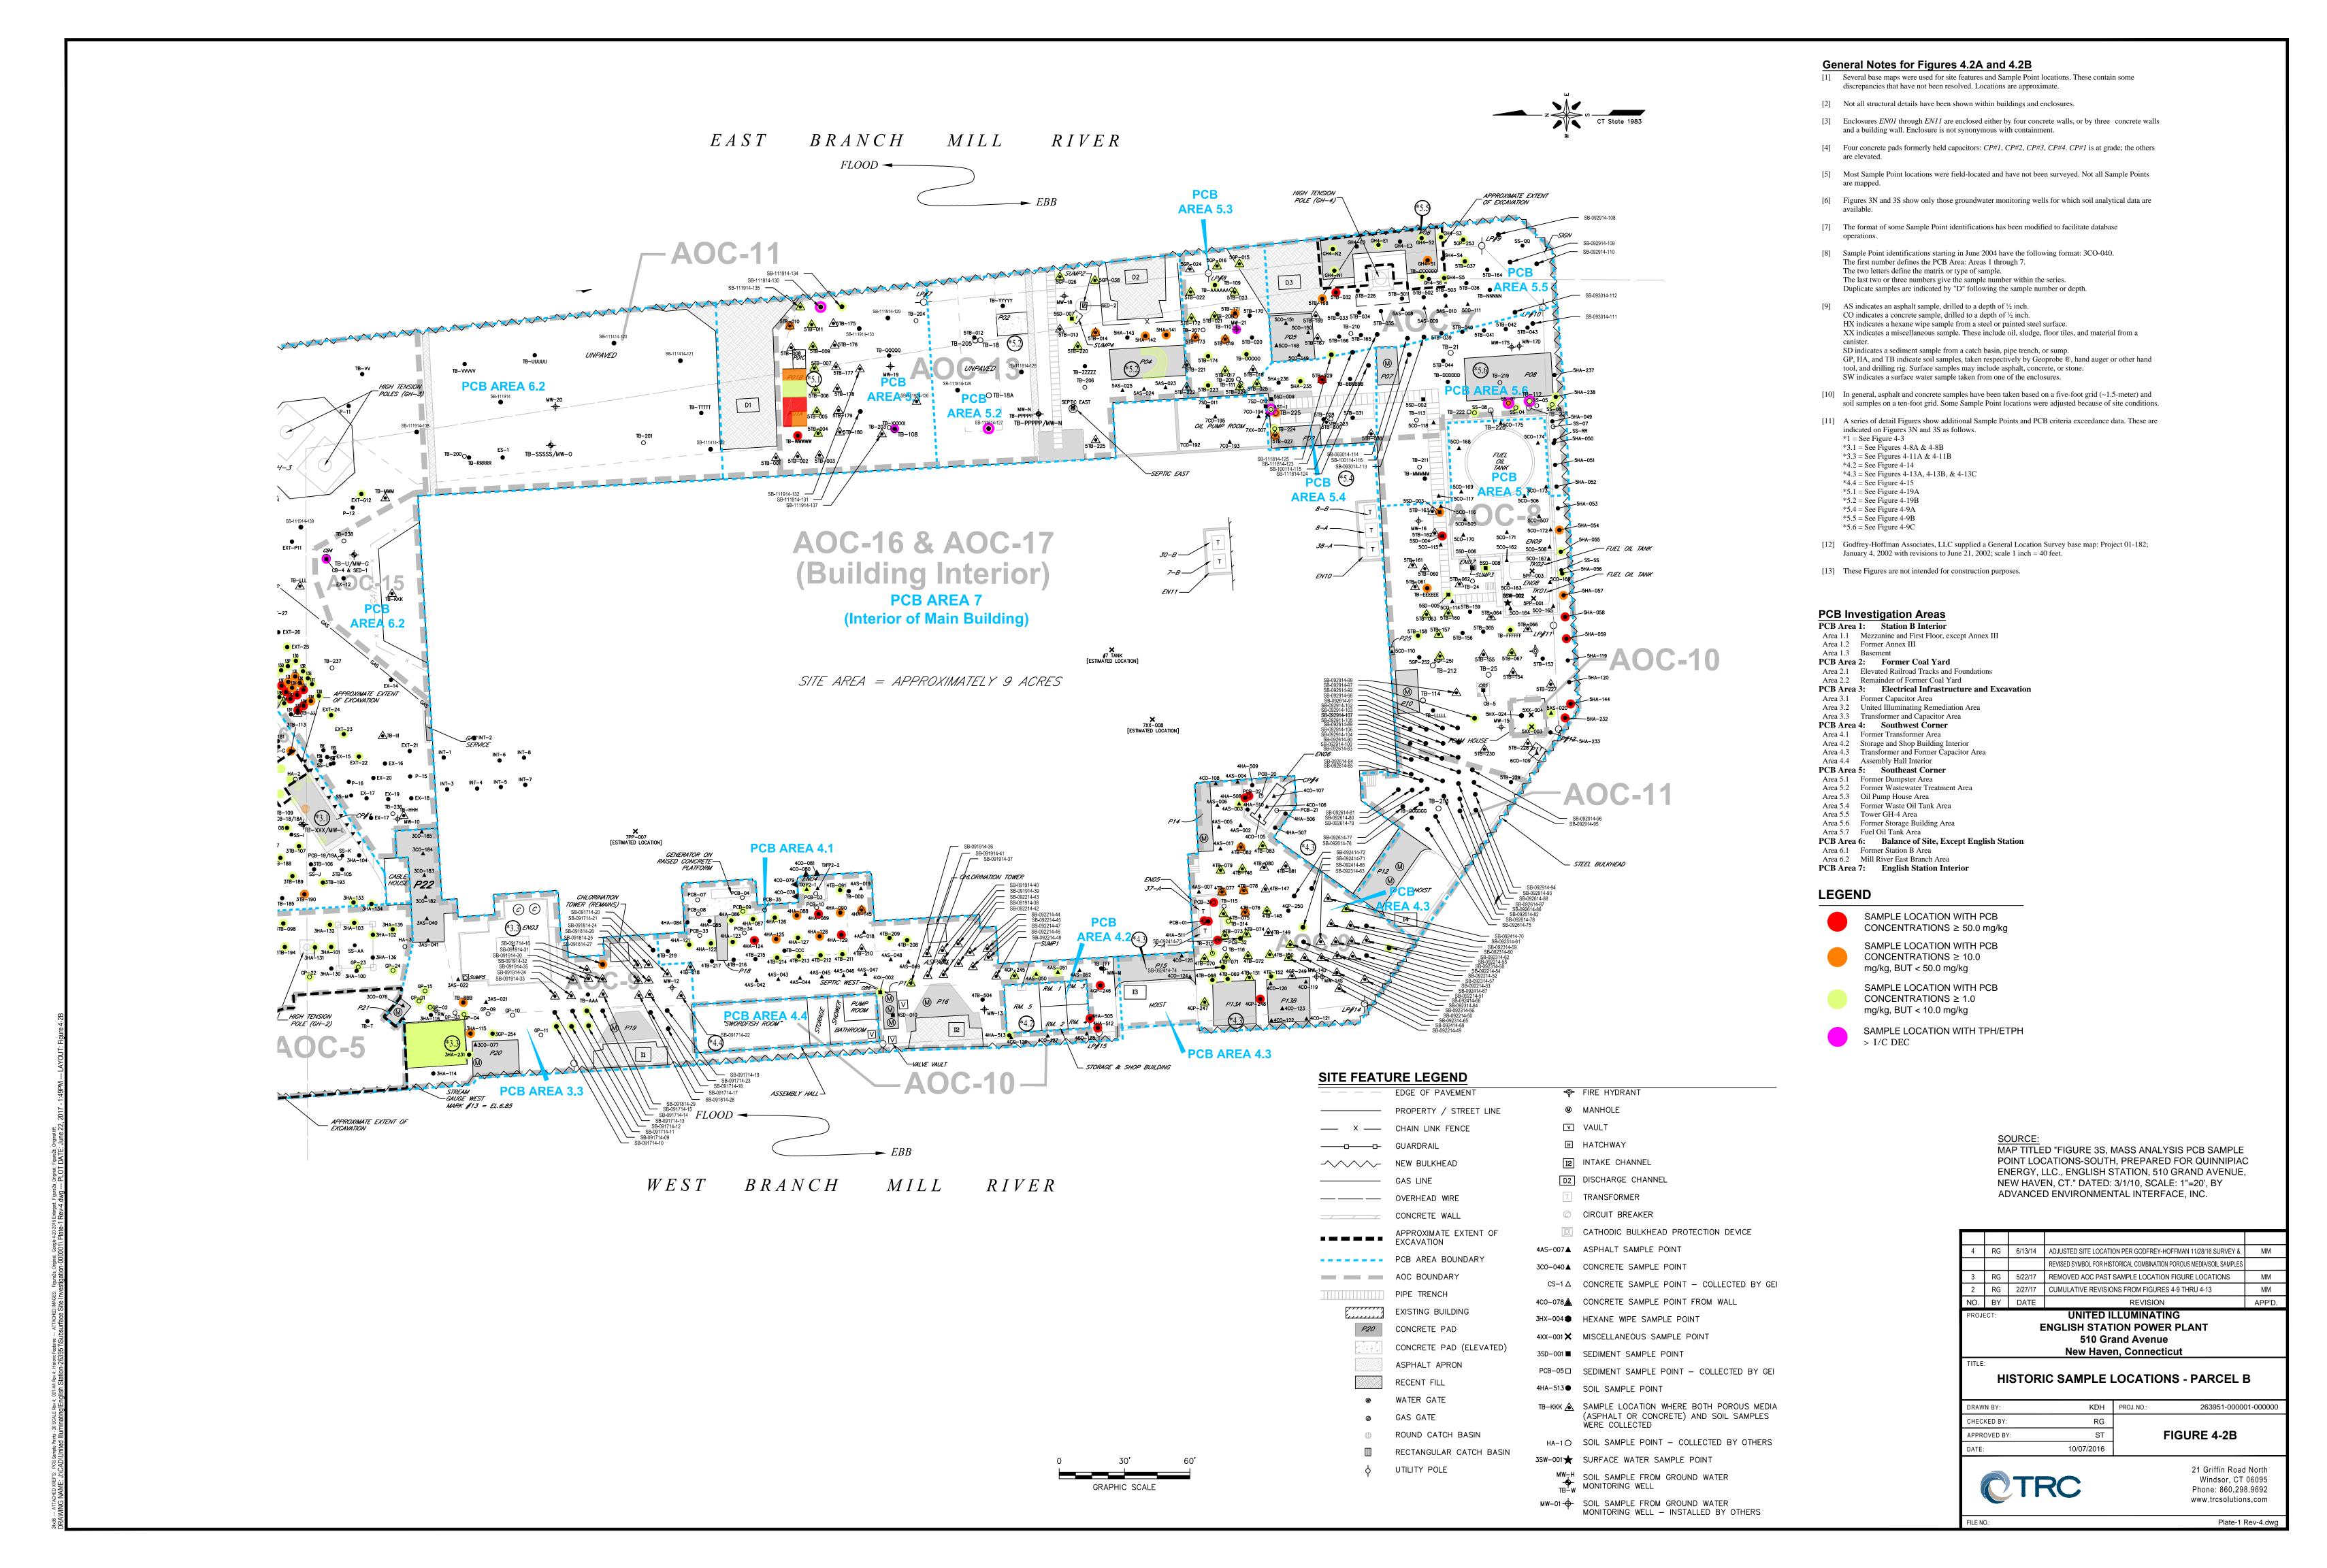

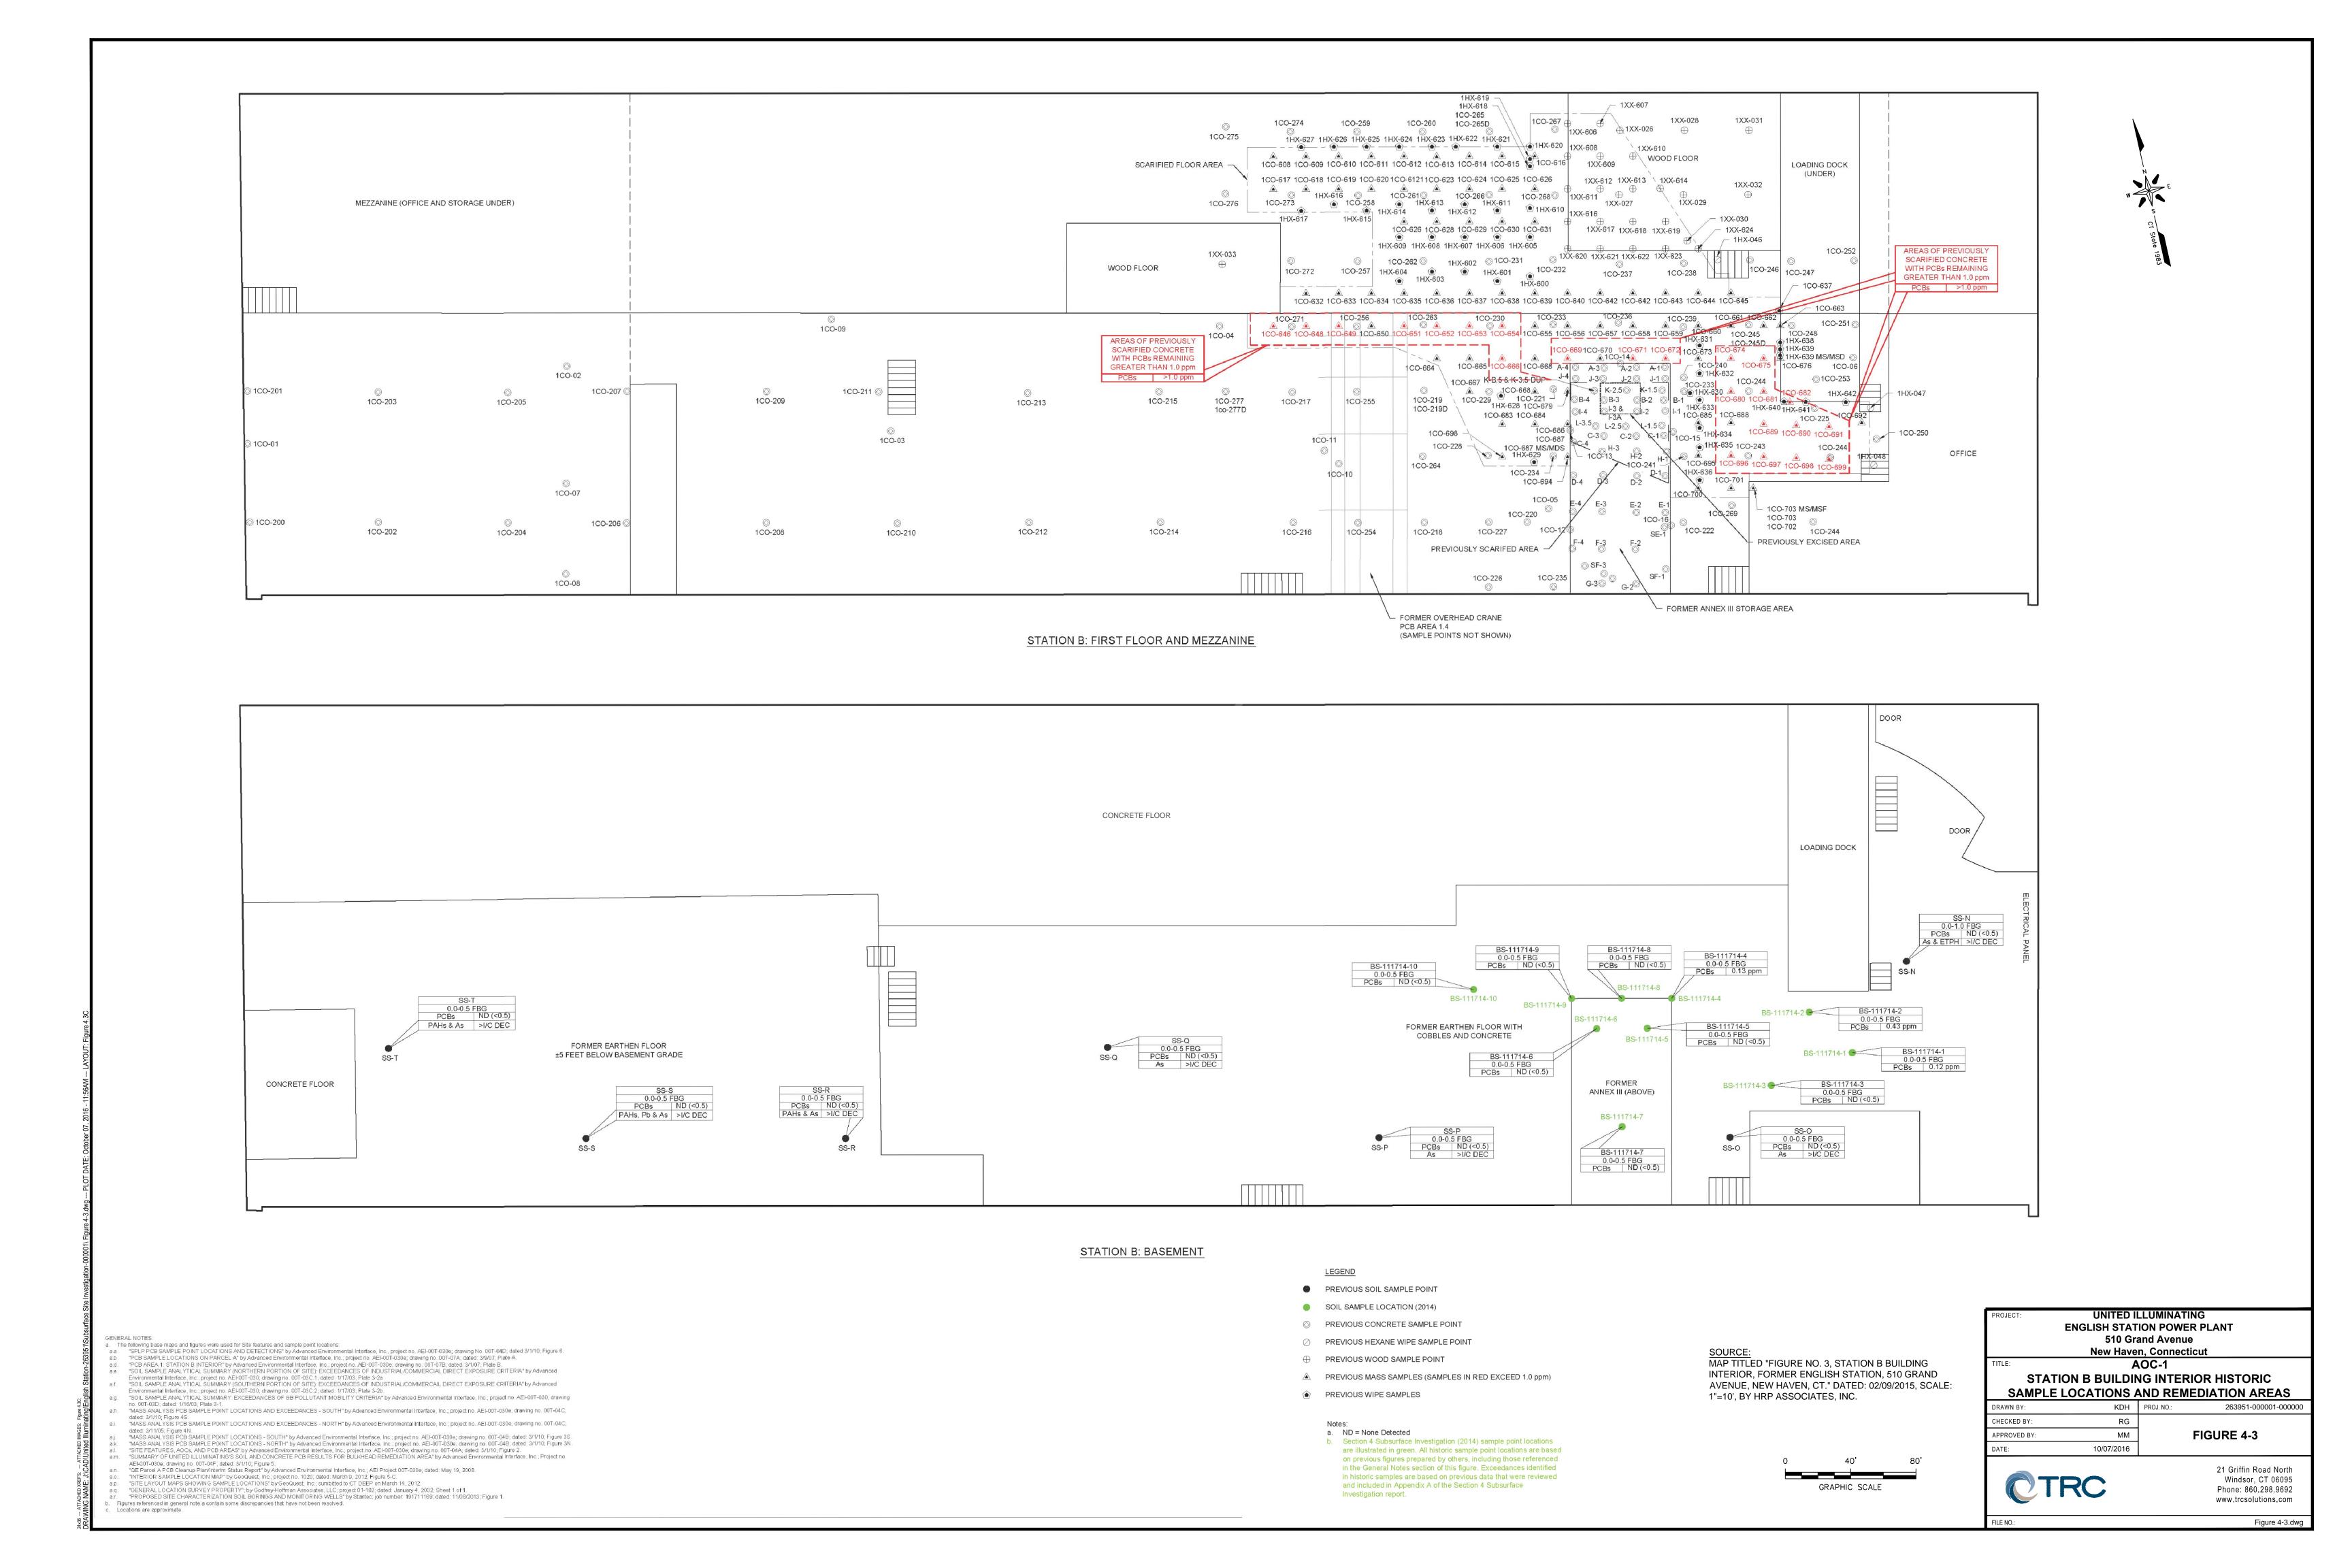

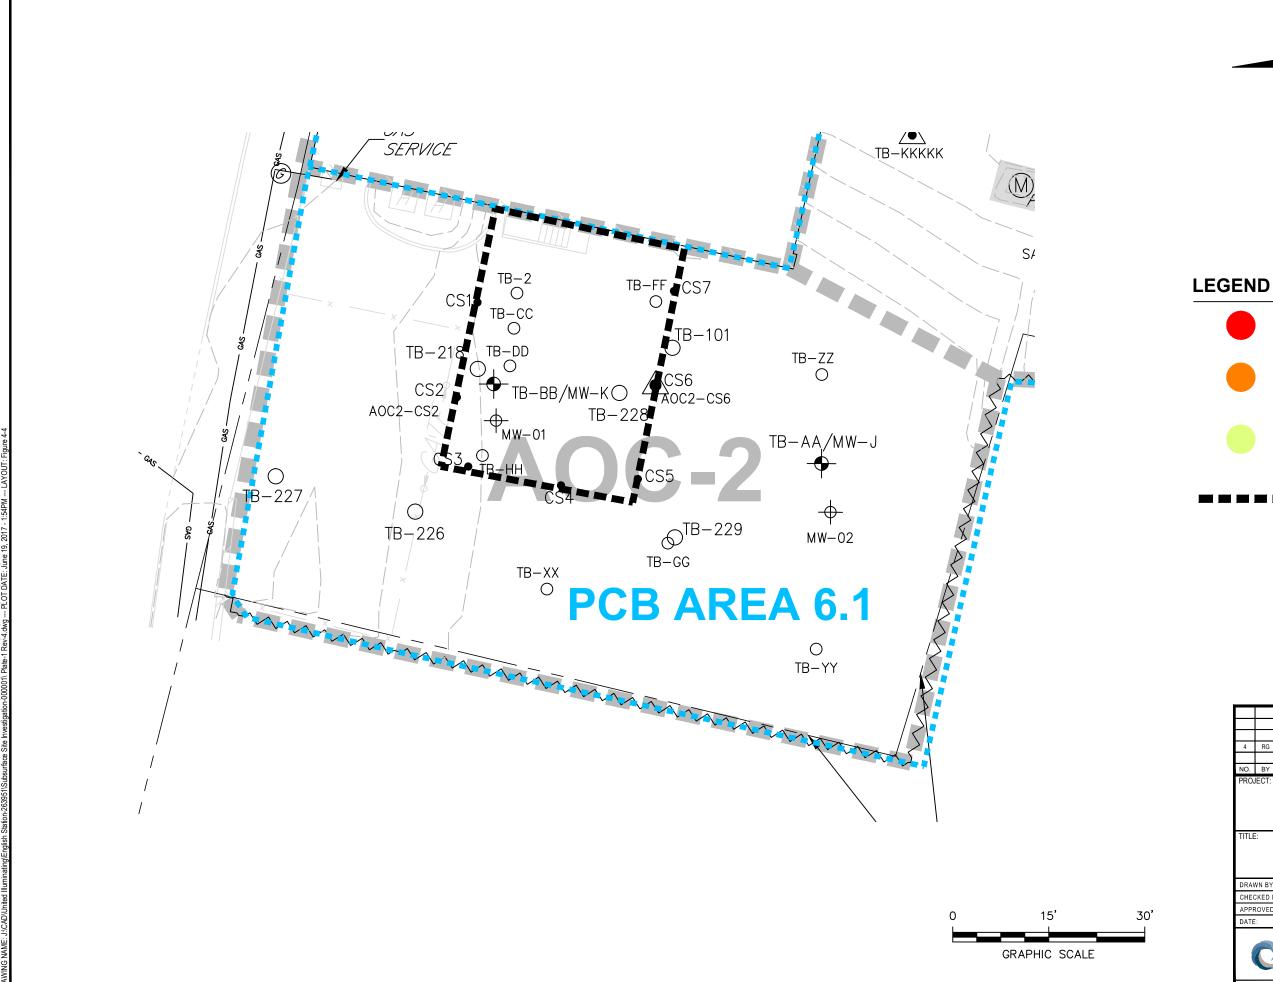

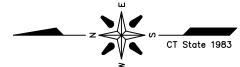

SAMPLE LOCATION WITH PCB CONCENTRATIONS ≥ 50.0 mg/kg



SAMPLE LOCATION WITH PCB CONCENTRATIONS ≥ 10.0 mg/kg, BUT < 50.0 mg/kg



SAMPLE LOCATION WITH PCB CONCENTRATIONS ≥ 1.0 mg/kg, BUT < 10.0 mg/kg



APPROXIMATE LIMIT OF EXCAVATION

NOTE:

SEE FIGURES 4-2A & 4-2B FOR NOTES, LEGEND AND LOCATION.

| 4 | RG | 6/13/17 | ADJUSTED SITE LOCATION PER GODFREY-HOFFMAN 11/28/16 SURVEY & | MM |
|-----|----|---------|---|--------|
| | | | REVISED SYMBOL FOR HISTORICAL COMBINATION POROUS MEDIA/SOIL SAMPLES | |
| NO. | BY | DATE | REVISION | APP'D. |
| | | | | |

UNITED ILLUMINATING ENGLISH STATION POWER PLANT 510 Grand Avenue New Haven, Connecticut


AOC-2 **HISTORIC SAMPLE LOCATIONS**


| DRAWN BY: | KDH | PROJ NO.: | 263951-000001-000000 |
|--------------|------------|-----------|----------------------|
| CHECKED BY: | RG | | |
| APPROVED BY: | MM | | FIGURE 4-4 |
| DATE: | 01/04/2017 | | |



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Plate-1 Rev-4.dwg



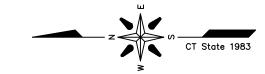

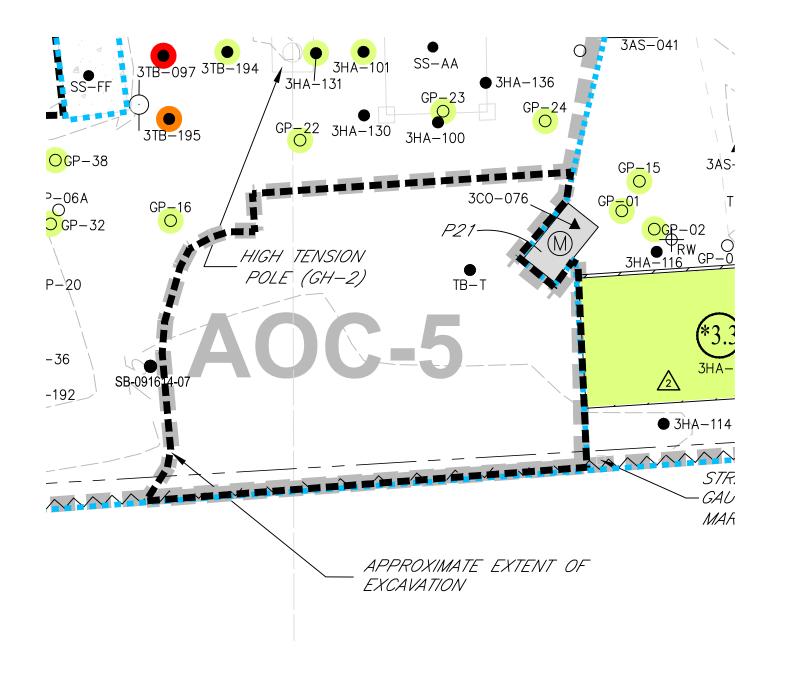LEGEND

SAMPLE LOCATION WITH PCB CONCENTRATIONS ≥ 50.0 mg/kg



SAMPLE LOCATION WITH PCB CONCENTRATIONS ≥ 10.0 mg/kg, BUT < 50.0 mg/kg



SAMPLE LOCATION WITH PCB CONCENTRATIONS ≥ 1.0 mg/kg, BUT < 10.0 mg/kg



APPROXIMATE LIMIT OF EXCAVATION

NOTE:

SEE FIGURES 4-2A & 4-2B FOR NOTES, LEGEND AND LOCATION.

| 4 | RG | 6/13/17 | ADJUSTED SITE LOCATION PER GODFREY-HOFFMAN 11/28/16 SURVEY | MM | |
|-----|----|---------|--|--------|--|
| NO. | BY | DATE | REVISION | APP'D. | |
| | | | | | |

UNITED ILLUMINATING
ENGLISH STATION POWER PLANT
510 Grand Avenue
New Haven, Connecticut

TITL

AOC-5
BULKHEAD PCB REMEDIATION AREA

| DRAWN BY: | KDH | PROJ NO.: | 263951-000001-000000 |
|--------------|------------|-----------|----------------------|
| CHECKED BY: | RG | | |
| APPROVED BY: | MM | | FIGURE 4-7 |
| DATE: | 10/07/2016 | | |




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Plate-1 Rev-4.dwg

0 15' 30'
GRAPHIC SCALE

al olation-zooso noubsuliade ole investigatoi-doodon Plate-i Nev4.∆wy --- PLOI DATE. Julie 10, 2017 - 5.5 ifini --- Datamentaliade ole investigatoi-doodon Plate-i Nev4.∆wy --- PLOI DATE. Julie 10, 2017 - 5.5 ifini --- Data

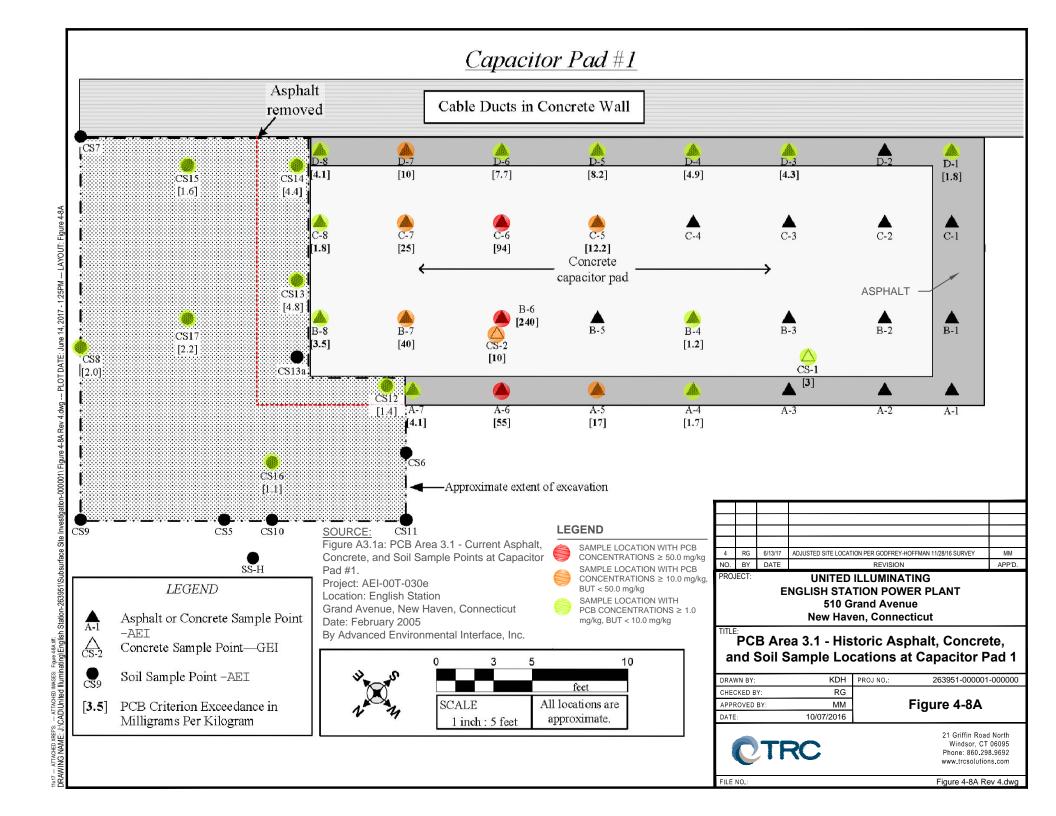

Capacitor Pad #2

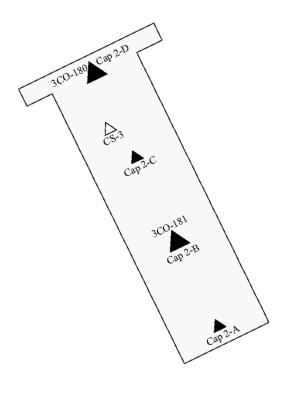



Figure A3.1c: PCB Area 3.1 - Concrete Sample

Points at Capacitor Pads #2 & #3. Project: AEI-00T-030e Location: English Station

Grand Avenue, New Haven, Connecticut

Date: February 2005

By Advanced Environmental Interface, Inc.

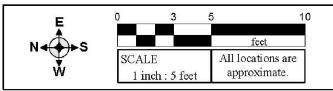

| 4 | RG | 6/13/17 | ADJUSTED SITE LOCATION PER GODFREY-HOFFMAN 11/28/16 SURVEY | MM | | | |
|-----|----|---------|--|--------|--|--|--|
| NO. | BY | DATE | REVISION | APP'D. | | | |
| | | | | | | | |

PROJECT:

UNITED ILLUMINATING
ENGLISH STATION POWER PLANT
510 Grand Avenue
New Haven, Connecticut

TITLE:

PCB Area 3.1 - Historic Concrete Sample Locations at Capacitor Pads 2 & 3

| DRAWN BY: | KDH | PROJ NO.: | 263951-000001-000000 |
|--------------|------------|-----------|----------------------|
| CHECKED BY: | RG | | |
| APPROVED BY: | MM | | Figure 4-8B |
| DATE: | 10/07/2016 | | G |



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No. Figure 4-8B Rev 4.dwg

тил? — итмонер жеге». — итмонер мимсв. Figure 448 иff. DRAWING NAME: J.ICADIUnited IlluminatinglEnglish Station-263951/Subsurface Site Investigation-000001/Figure 4-8B Rev 4.dwg.

Cap 3-A

CS-4

Cap 3-A


3CO-180


LEGEND


Concrete Sample Point


Concrete Sample Point-GEI

Concrete Sample Point-Adjacent

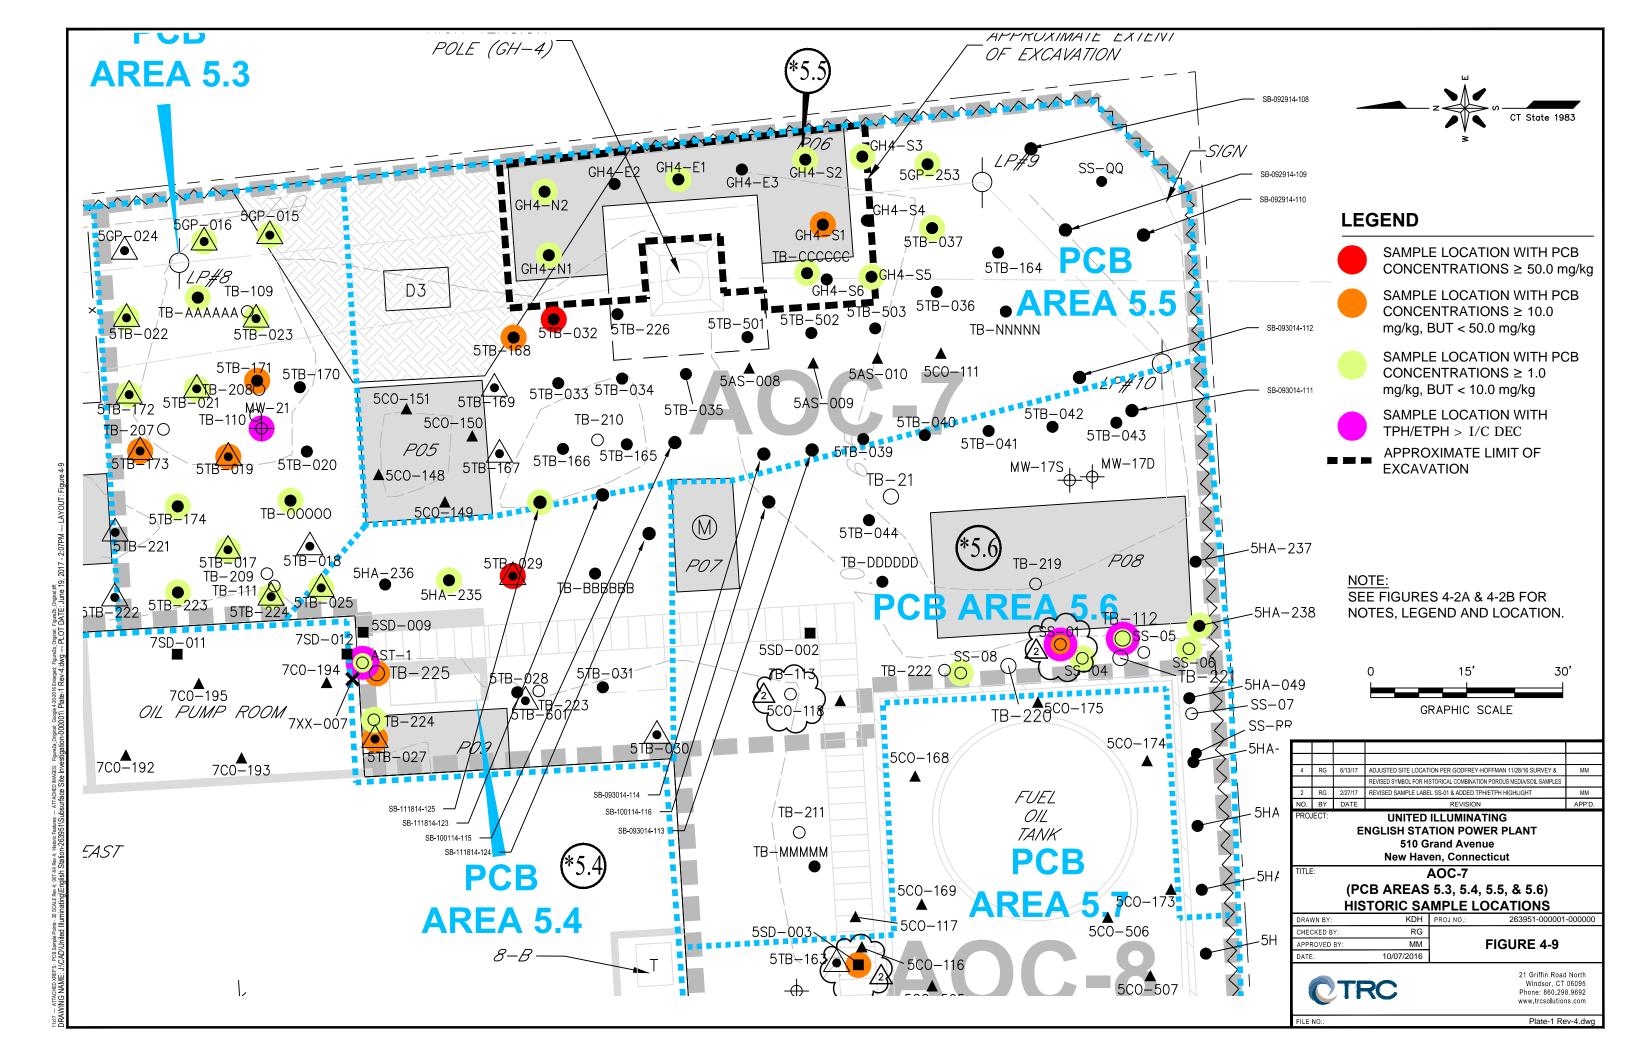

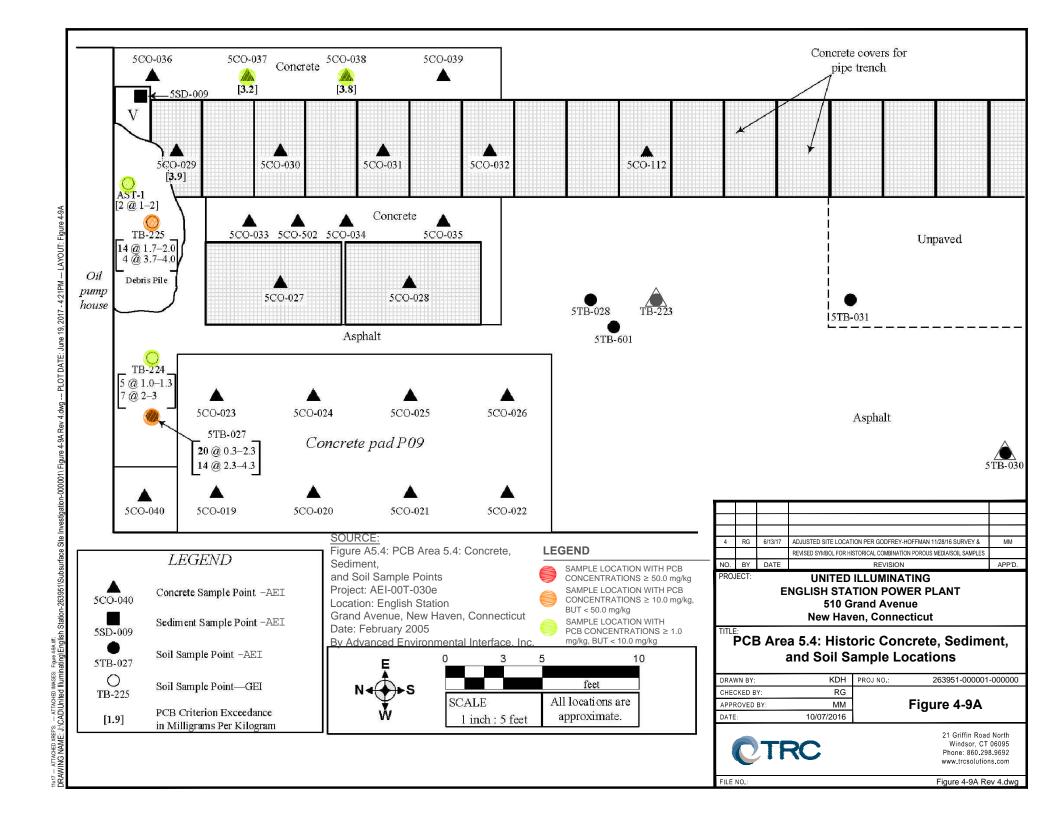

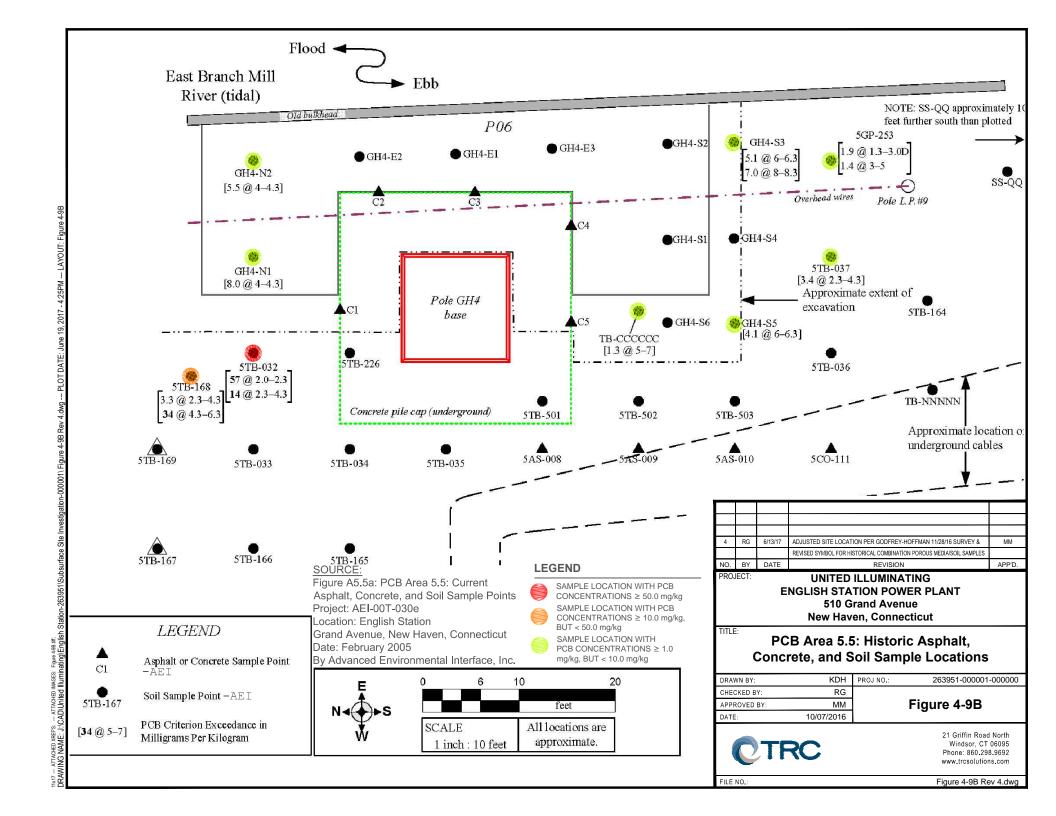

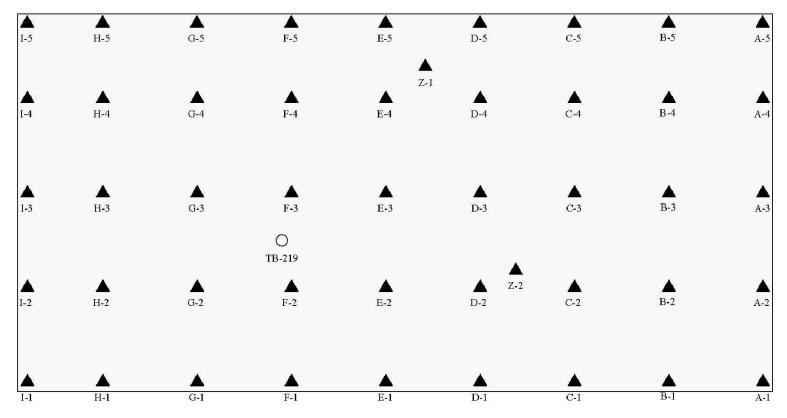

SOURCE:

Figure A5.6: PCB Area 5.6: Concrete and Soil Sample Points at Concrete Pad P08
Project: AEI-00T-030e
Location: English Station
Grand Avenue, New Haven, Connecticut

Date: February 2005

By Advanced Environmental Interface, Inc.

| | LEGEND |
|------------------|---------------------------|
| ▲ 5CO-026 | Concrete Sample Point-AEI |
| O TB-219 | Soil Sample Point—GEI |

| E | 0 | 3 | 5 | <u>1</u> 0 |
|-------|--------|---------|-------|--------------------------|
| N.A. | | | | feet |
| W - 5 | SCALE | - 0 | | locations are proximate. |
| yv | l inch | 1:5 fee | et ap | proximate. |

| 4 | RG | 6/13/17 | ADJUSTED SITE LOCATION PER GODFREY-HOFFMAN 11/28/16 SURVEY | MM |
|-----|----|---------|--|--------|
| NO. | BY | DATE | REVISION | APP'D. |

PROJECT: UNITED ILLUMINATING
ENGLISH STATION POWER PLANT
510 Grand Avenue
New Haven, Connecticut

PCB Area 5.6: Historic Concrete and Soil Sample Locations at Concrete Pad P08


| DRAWN BY: | KDH | PROJ NO.: | 263951-000001-000000 |
|--------------|------------|-----------|----------------------|
| CHECKED BY: | RG | | |
| APPROVED BY: | MM | | Figure 4-9C |
| DATE: | 10/07/2016 | | • |
| DATE: | 10/07/2016 | | |




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NO. Figure 4-9C Rev 4.dwg

Plate-1 Rev-4.dwg



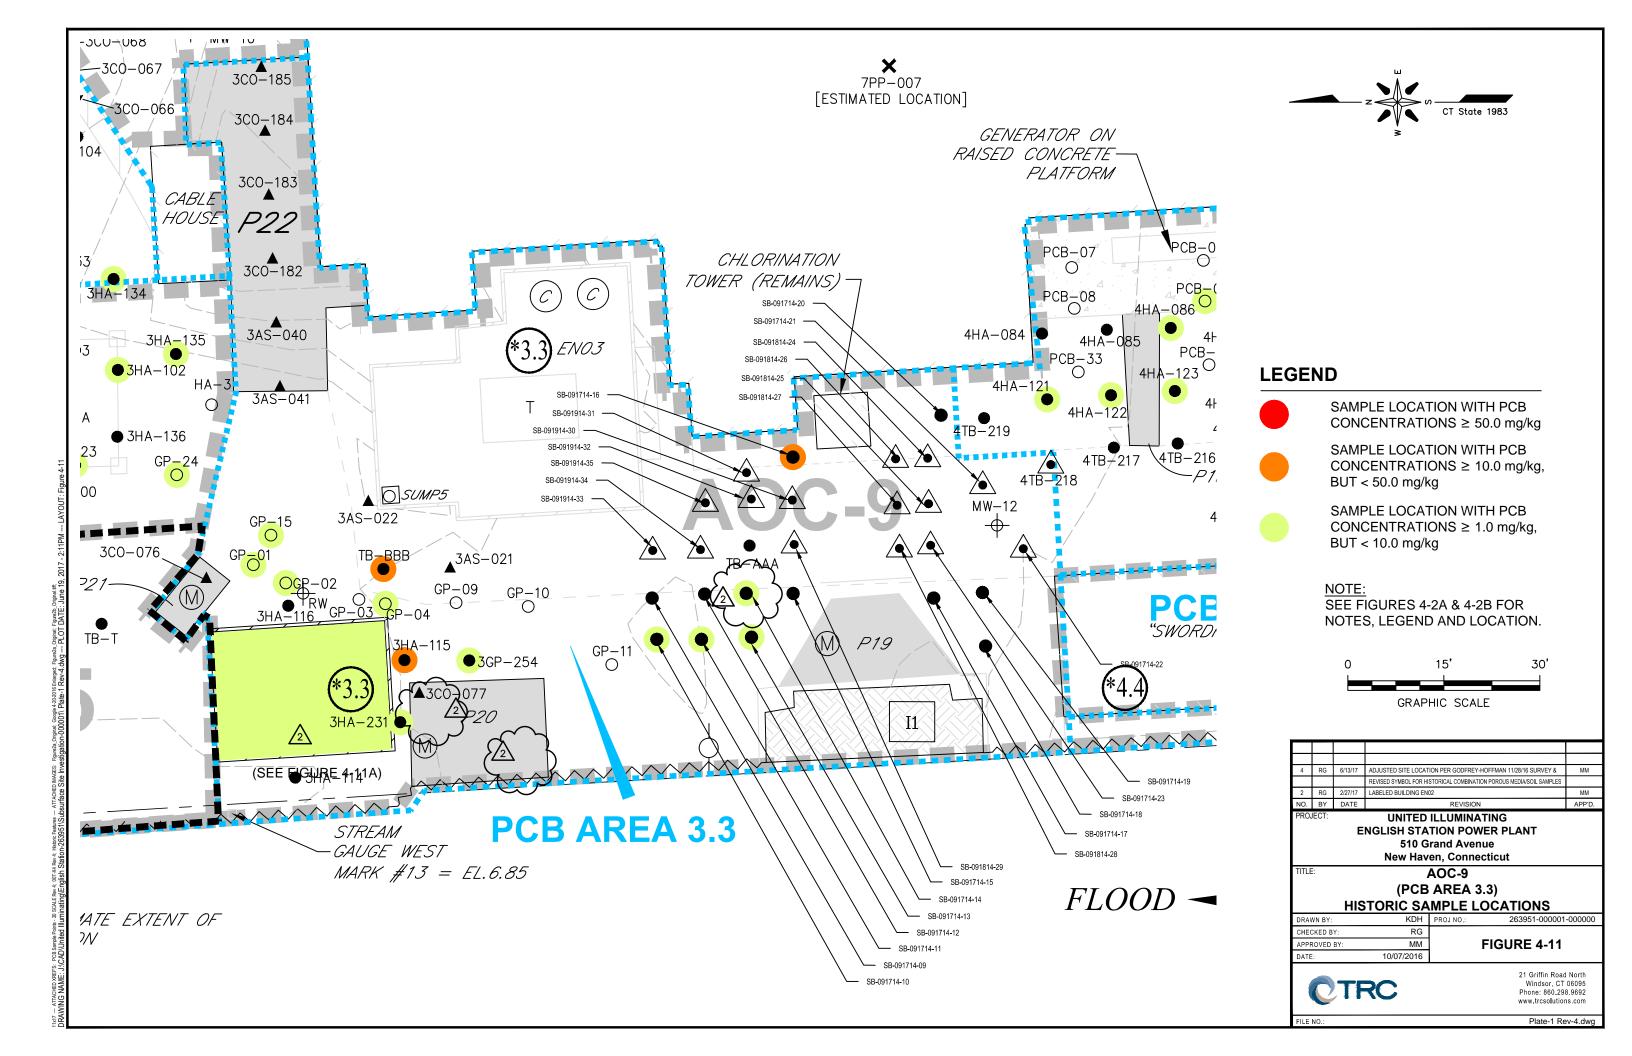

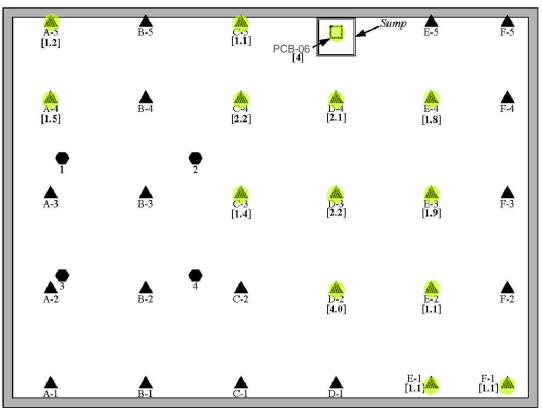NOTES:

- Hexane wipe samples were taken from an elevated steel deck above the enclosure concrete floor.
- 2. Many enclosure details are not shown.

SOURCE:

Figure A3.3a: PCB Area 3.3: Concrete, Hexane Wipe, and Sediment Sample Points at Enclosure EN02.

Project: AEI-00T-030e Location: English Station Grand Avenue, New Haven, Connecticut

Date: February 2005

By Advanced Environmental Interface, Inc.

LEGEND

SAMPLE LOCATION WITH PCB CONCENTRATIONS ≥ 50.0 mg/kg SAMPLE LOCATION WITH PCB CONCENTRATIONS ≥ 10.0 mg/kg, BUT < 50.0 mg/kg

SAMPLE LOCATION WITH PCB CONCENTRATIONS ≥ 1.0 mg/kg, BUT < 10.0 mg/kg

| | PROJECT: | | | LINITED II I LIMINATING | |
|-----|----------|----|---------|--|--------|
| | NO. | BY | DATE | REVISION | APP'D. |
| | 2 | RG | 2/27/17 | REV PCB-06 LABEL | MM |
| | 4 | RG | 6/13/17 | ADJUSTED SITE LOCATION PER GODFREY-HOFFMAN 11/28/16 SURVEY | MM |
| d | | | | | |
| | | | | | |
| - 1 | | | | | |

UNITED ILLUMINATING
ENGLISH STATION POWER PLANT
510 Grand Avenue
New Haven, Connecticut

PCB Area 3.3: Historic Concrete,
Hexane Wipe, and Sediment Sample
Locations at Enclosure EN02

| | DRAWN BY: | KDH | PROJ NO.: | 263951-000001-000000 | |
|--|--------------|------------|-----------|----------------------|--|
| | CHECKED BY: | RG | | | |
| | APPROVED BY: | MM | | Figure 4-11A | |
| | DATE: | 10/07/2016 | | · · | |



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Figure 4-11A Rev 4.dwg


A-1
Concrete Sample Point –AEI
Hexane Wipe Sample Point –AEI
PCB-6
Sediment Sample Point—GEI
PCB Criterion Exceedance in
Milligrams per Kilogram

LEGEND

N SCALE All locations are approximate.

INATA - ATACHED XRETS. - ATTACHED MAGES. Figure 4:11A Rev. 2.
DRAWING NAME: J.!CADIUnied IlluminatinglEnglish Station-263951/Subsurface Site Investigation-0000011 Figure 4-11A Rev 4, dwg -- PLOT DATE: June 14, 2017 - 2:56PM -- LAYOUT: Figure 4.11A



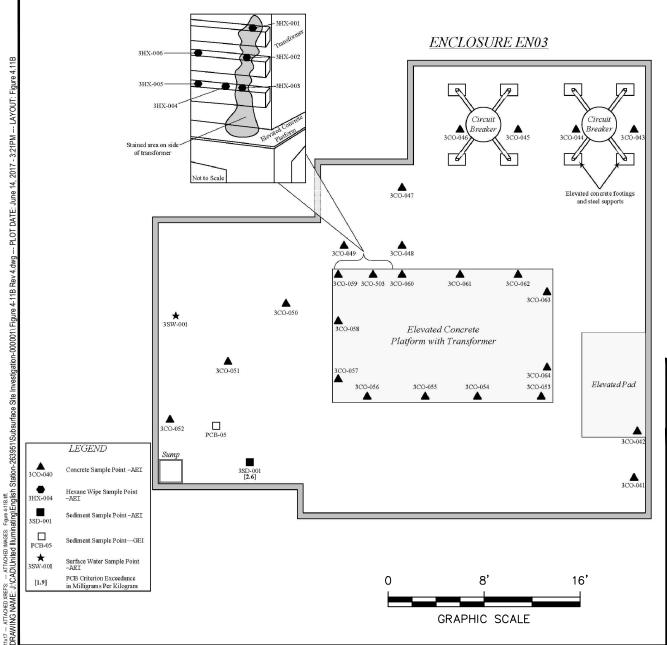

NOTES:

- 1. 3HX-004 was taken from area of intermediate staining.
- 2. Transformer has blue sticker indicating fluid contains less than 50 ppm PCB.
- 3. Elevated circuit breakers have green stickers indicating fluid contains less than 1 ppm PCB.
- 4. Many enclosure details are not shown.
- 5. All Locations Are Approximate.

SOURCE:

Figure A3.3b: PCB Area 3.3: Concrete, Hexane Wipe, Sediment, and Surface Water Sample Points at

Enclosure EN03. Project: AEI-00T-030e

Location: English Station

Grand Avenue, New Haven, Connecticut

Date: February 2005

By Advanced Environmental Interface, Inc.

All Locations Are Approximate

| 4 | RG | 6/13/17 | ADJUSTED SITE LOCATION PER GODFREY-HOFFMAN 11/28/16 SURVEY | |
|-----|----|---------|--|--|
| NO. | BY | DATE | REVISION | |

PROJECT:

UNITED ILLUMINATING ENGLISH STATION POWER PLANT 510 Grand Avenue New Haven, Connecticut

PCB Area 3.3: Historic Concrete, Hexane Wipe, Sediment, and Surface Water Sample Locations at Enclosure EN03

| DRAWN BY: | KDH | PROJ NO.: | 263951-000001-000000 | | |
|--------------|------------|-----------|----------------------|--|--|
| CHECKED BY: | RG | | | | |
| APPROVED BY: | MM | | Figure 4-11B | | |
| DATE: | 10/07/2016 | 1 | • | | |



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NO.: Figure 4-11B Rev 4.dwg

